

	SCHEDULE OF DRAWINGS	
SHEET#	TITLE	REV
DD000	COVER SHEET	D
DD001	CONSTRUCTION NOTES	D
DD100	EXISTING SITE PLAN - OVERVIEW	D
DD101	EXISTING SITE PLAN - SHEET 1	D
DD300	ROADING PLAN - OVERVIEW	D
DD301 - 304	ROADING PLAN - SHEETS 1 - 4	D
DD310 - 311	MARSDEN POINT ROAD INTERSECTION PLAN - SHEETS 1 - 2	D
DD320 - 323	ROAD TYPICAL SECTIONS - SHEETS 1 - 4	D
DD325	ROAD TYPICAL PAVEMENT & KERB DETAILS	D
DD326	COMBINED SERVICE TRENCH & PAVEMENT CHECK OUT DETAILS	D
DD327	PRAM CROSSING DETAILS & RAISED SPEED TABLE TYPICAL SECTION	D
DD330 - 333	ROAD LONGITUDINAL SECTIONS - SHEETS 1 - 4	D
DD340 - 342	ROAD 1 CROSS SECTIONS - SHEETS 1 - 3	D
DD343 - 345	ROAD 2 CROSS SECTIONS - SHEETS 1 - 3	D
DD346	ROAD 3 CROSS SECTIONS - SHEET 1	D
DD347	ROW 1 CROSS SECTIONS - SHEET 1	D
DD348 - 349	MARSDEN POINT ROAD CROSS SECTIONS - SHEETS 1 - 2	D
DD360 - 364	ROAD KERB RETURNS - SHEETS 1 - 5	D
DD370	ROAD LINEMARKING & SIGNPOSTING PLANS - OVERVIEW	D
DD371 - 374	ROAD LINEMARKING & SIGNPOSTING PLANS - SHEETS 1 - 4	D
DD380 - 381	VEHICLE CROSSING PLANS - SHEETS 1 - 2	D
DD385	VEHICLE CROSSING DETAILS	D
DD400	STORMWATER PLAN - OVERVIEW	D
DD401 - 404	STORMWATER PLAN - SHEETS 1 - 4	D
DD405 - 406	STORMWATER OVERLAND FLOWPATHS & FLOODED WIDTHS (100YR + CC) - SHEETS 1 - 2	D
DD410 - 411	STAGE 1 STORMWATER CATCHMENTS FOR PIPE NETWORKS (5YR + CC) - SHEETS 1 - 2	D
DD415	POND CATCHMENTS AREAS	D
DD420 - 426	STORMWATER LONGSECTIONS - SHEETS 1 - 7	D
DD430	STORMWATER POND TYPICAL DETAILS	D
DD450	SANITARY SEWER PLAN - OVERVIEW	D
DD451 - 454	SANITARY SEWER PLAN - SHEETS 1 - 4	D
DD460 - 462	SANITARY SEWER LONGSECTIONS - SHEETS 1 - 3	D
DD470 - 475	DRAINAGE TYPICAL DETAILS - SHEETS 1 - 6	D
DD500	POTABLE WATER PLAN - OVERVIEW	D
DD501 - 504	POTABLE WATER PLAN - SHEETS 1 - 4	D
DD510 - 511	POTABLE WATER TYPICAL DETAILS - SHEETS 1 - 2	D
DD600 - 605	FIRST GAS & CHANNEL PIPELINES SURVEY PLAN AND LONGSECTIONS	D


**Approved Plans -**

Whangarei District Council RCA -SD2200045 JF 19/12/2022

# **CIVIL ENGINEERING DESIGN** FOR ENGINEERING APPROVAL

BREAM BAY BUSINESS HUB - STAGE 1A & 1

PROJECT REF: P0318

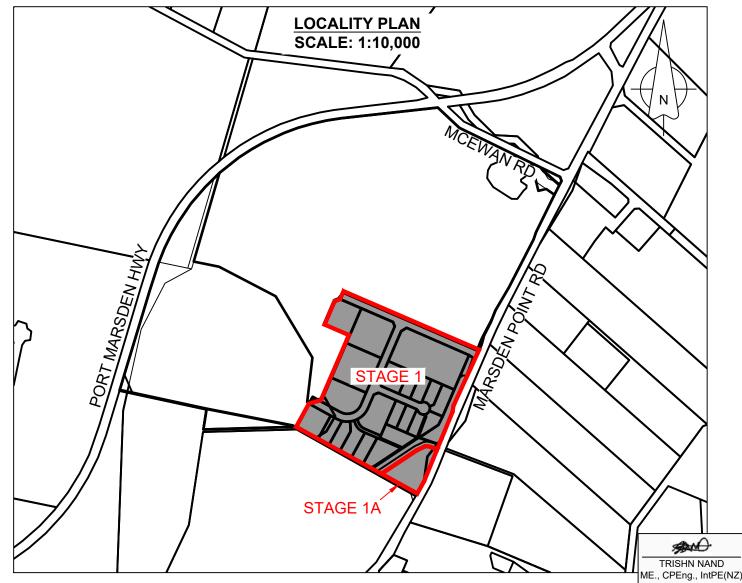

#### **GENERAL NOTES:**

- ALL WORKS SHALL COMPLY WITH ALL RELEVANT NZ STANDARDS, THE NZ BUILDING CODE & TERRITORIAL AUTHORITY REGULATION INCLUDING THE CURRENT VERSIONS OF NZS 3604 AND NZS 4404. ANY CONFLICTS TO BE DISCUSSED WITH THE ENGINEER PRIOR TO CONSTRUCTION.
- ENGINEERING DRAWINGS SHALL BE READ IN CONJUNCTION WITH THE SPECIFICATIONS, ARCHITECTURAL, CIVIL AND ENGINEERING SERVICES DOCUMENTS.
- 3. UNLESS OTHERWISE NOTED ALL LEVELS ARE IN METERS, AND ALL DIMENSIONS ARE METRIC, AND SHALL BE CHECKED BY CONTRACTOR PRIOR TO CONSTRUCTION.
- 4. DIMENSIONS SHALL NOT BE OBTAINED BY SCALING FROM DRAWINGS
- 5. ALL DISCREPANCIES SHALL BE REFERRED TO THE ENGINEER FOR RESOLUTION BEFORE PROCEEDING WITH THE WORK.
- ALL MATERIAL AND WORKMANSHIP SHALL BE IN ACCORDANCE
  WITH THE CURRENT CODES OF PRACTICE EXCEPT WHERE
  VARIED BY THE SPECIFICATION AND/OR DRAWINGS.
- WHERE PROPRIETY PRODUCTS ARE SPECIFIED IN THE DOCUMENTS THE CONTRACTOR MAY SUBMIT AN ALTERNATIVE PRODUCT FOR APPROVAL.
- THE CONTRACTOR IS TO DISCUSS THE REQUIREMENTS OF ALL THE SITE INSPECTIONS FOR THE ISSUE OF THE PS4 PRIOR TO CONSTRUCTION
- 9. ONLY WDC APPROVED CONTRACTORS TO BE USED FOR ALL LIVE CONNECTIONS.
- 10. WDC REQUIRES 24 HOURS NOTICE BEFORE ANY INSPECTION.
- 11. ALL DIMENSIONS AND LEVELS ARE SUBJECT TO FINAL SURVEY.
- 12. ALL WORKS SHALL BE CARRIED OUT UNDER THE CURRENT HEALTH AND SAFETY WORK ACT.
- 13. THESE NOTES APPLY TO THE ENTIRETY OF THE DRAWING SET.

#### **EXISTING SERVICES:**

- THE LOCATIONS OF UNDERGROUND SERVICES SHOWN ON THESE DRAWINGS ARE APPROXIMATE ONLY AND BASED ON INFORMATION PROVIDED BY TERRITORIAL AUTHORITIES AND NETWORK UTILITY OPERATORS. WE ACCEPT NO LIABILITY FOR THE INACCURACIES.
- 2. CONTRACTOR SHALL LOCATE AND PROTECT EXISTING SERVICES PRIOR TO CONSTRUCTION.

#### ROADING:

- 1. DETAILED PAVEMENT DESIGN IN ACCORDANCE WITH CURRENT AUSTROADS PAVEMENT DESIGN GUIDELINES FOR ROADS 1, 2, AND 3 IS TO BE COMPLETED AFTER SUBGRADE STRENGTH IS KNOWN AND REVIEWED BY NTA FOR APPROVAL. ASSUMPTION OF 7% CBR WILL NEED TO BE CONFIRMED AS STATED IN PAVEMENT DESIGN INCLUDING THE CONNECTION TO MARSDEN POINT ROAD.
- 2. PAVEMENT AND SURFACE CONSTRUCTION IS TO ONLY OCCUR BETWEEN SEPTEMBER AND MARCH UNLESS APPROVED BY NTA.
- 3. ALL PAVEMENT MATERIALS AND WORK STANDARDS TO BE IN ACCORDANCE WITH ALL RELEVANT NZ STANDARDS, TERRITORIAL AUTHORITY REGULATION INCLUDING THE CURRENT VERSION OF NZS 4404
- 4. THE CONTRACTOR SHALL REINSTATE ALL DAMAGE TO ADJACENT FEATURES CAUSED BY THE WORKS.
- ROAD MARKINGS AND SIGNAGES SHALL BE IN ACCORDANCE WITH CURRENT NZTA MANUAL OF TRAFFIC SIGNS AND MARKINGS (MOTSAM). ALL SIGNS TO BE VIP GRADE REFLECTIVITY.

#### CONCRETE:

- ALL MATERIALS AND WORKMANSHIP SHALL BE IN ACCORDANCE WITH NZS3109 AND NZS3101 SUBJECT TO RELEVANT SECTIONS OF THE SPECIFICATION.
- 2. NO CONCRETE SHALL BE PLACED UNTIL WDC HAS HAD THE OPPORTUNITY TO OBSERVE THAT THE DRAWINGS AND SPECIFICATIONS HAVE BEEN COMPLIED WITH.
- ALL CONCRETE SUPPLY AND PRODUCTION SHALL BE IN ACCORDANCE WITH NZS3104, 3101:2017.
- 4. WHERE THE LOCATION OF CONSTRUCTION JOINTS IS NOT SPECIFICALLY DETAILED ON THE STRUCTURAL DRAWINGS, CONSTRUCTION JOINTS SHALL BE COORDINATED WITH THE ENGINEER/WDC AS REQUIRED. THE CONSTRUCTOR SHALL ALLOW FOR ALL SUCH CONSTRUCTION JOINTS.

#### **CONCRETE PAVEMENTS:**

- UPON EXPOSURE OF SUBGRADE AT PAVEMENT BASE CONTACT WDC FOR INSPECTION AND INSTRUCTION TO REMOVE AND REPLACE ANY SOFT AREAS PRIOR TO COMMENCING CONSTRUCTION OF PAVEMENT LAYERS. EXCAVATED MATERIAL TO BE REMOVED FROM SITE.
- 2. SUPPLY AND COMPACT BASECOURSE LAYER IN ACCORDANCE WITH CROSS SECTIONS SUPPLIED.
- 3. CONCRETE USED SHALL BE SPECIAL GRADE WITH 28 DAY COMPRESSIVE STRENGTH OF 30MPA.
- 4. ALL JOINTS SHALL BE INSTALLED AT THE LOCATIONS INDICATED. SAW CUT JOINTS SHALL BE CUT WITHIN 24 HOURS OF CONCRETE BI ACCEMENT
- 5. ALL CONCRETE SHALL BE CURED BY AN APPROVED METHOD FOR AT LEAST 7 DAYS AFTER POURING. CURING METHOD SHALL BE PROPOSED TO ENGINEER FOR APPROVAL. SOME PROPRIETARY SURFACE TREATMENTS MAY NOT BE APPROVED.
- 6. SLAB SURFACE TOLERANCES SHALL NOT EXCEED 5MM DEVIATION IN A 3M STRAIGHT EDGE.
- 7. SLAB THICKNESSES GIVEN ARE MINIMUM THICKNESSES AND EXCLUSIVE OF ANY APPLIED FINISHES.
- 8. SLAB SURFACES SHALL BE NEATLY BROOM FINISHED.
- 9. ALL SLAB JOINTS ARE TO BE SEALED WITH AN APPROVED WATERPROOF FLEXIBLE SEALANT AFTER 28 DAYS AND PRIOR TO PRACTICAL COMPLETION.

#### **EARTHWORKS**:

- 1. ALL EARTH FILL TO BE CONSTRUCTED IN GENERAL ACCORDANCE WITH NZS4431:1989 OR UNLESS SPECIFIED BY THE ENGINEER AT THE TIME OF CONSTRUCTION.
- 2. COMPACTION IN BASE OF PIPE TRENCHES TO ACHIEVE CLEGG 10.
- FILL COMPACTION IN MAXIMUM LAYERS OF 200mm THICK WITH A 2 TONNE ROLLER - TRACK ROLLING WITH A DIGGER IS NOT ACCEPTABLE.
- 4. FILL CONTROL TESTING WDC TO INSPECT AND TEST EVERY 3RD LAYER PLACED (600mm INTERVALS).
- 5. EROSION CONTROL ALL SILT CONTROL MEASURES SHALL BE INSTALLED IN ACCORDANCE WITH GD05 AND PLACED PRIOR TO COMMENCEMENT OF EARTHWORKS. SUCH MEASURES SHALL BE SUBJECT TO FURTHER ADDITIONS AND ALTERATIONS, WHERE CONSIDERED NECESSARY, AS DIRECTED BY THE PROJECT MANAGER OR NRC, DURING THE PROGRESSION OF WORKS. IT IS ADVISED TO CONTACT NRC PRIOR TO COMMENCEMENT OF EARTHWORKS, AFTER INSTALLATION OF EROSION AND SEDIMENT CONTROL DEVICES TO ENSURE THEY HAVE BEEN INSTALLED TO THE SATISFACTION OF NRC.

PROJECT DETAILS

#### **INSPECTIONS / SITE VISITS REQUIRED:**

- 1. PRE-CONSTRUCTION SITE MEETING WITH CONTRACTOR AND WDC.
- ALL INSPECTIONS AS REQUIRED IN THE APPROVED INSPECTIONS AND TEST PLAN (ITP). ALL WORKS SHOULD ENSURE THE INSPECTION AND TEST PLAN IS CAREFULLY ACTIONED PRIOR TO PROCEEDING WITH CONSTRUCTION.

#### **EARTHWORKS RESOURCE CONSENT:**

BULK EARTHWORKS WILL BE CARRIED OUT IN ACCORDANCE WITH THE NORTHLAND REGIONAL COUNCIL RESOURCE CONSENT FILE NUMBER 43297 (EXPIRY DATE: 31/01/2027).

#### **ACID SULPHATE NOTES:**


ACID SULPHATE TESTING TO BE COMPLETED ALONG PIPELINE ROUTES TO DETERMINE WHERE ACID RESISTANT MATERIALS ARE REQUIRED.
GEOTECHNICAL ENGINEER TO PREPARE PLAN OF ACID SULPHATE AREAS WHERE THE FOLLOWING SPECIFIC ACID SULPHATE NOTES WILL APPLY:

- ALL CONCRETE MANHOLES, CESSPITS, HEADWALLS AND PIPES TO BE HYDRUA CONCRETE.
- ALL STORMWATER, SEWER AND WATERMAIN PIPES TO HAVE FULL SURROUND PIPE EMBEDMENT.
- ALL MANHOLE HAUNCHING TO BE 30MPa CONCRETE.
- 4. ALL METAL FITTINGS OR CONNECTIONS TO BE COATED WITH PAINT OR WRAPPED FOR PROTECTION.
- LIME TO BE APPLIED AT A RATE OF 0.5kg/m² DIRECTLY UNDER ALL CONCRETE ROADS, KERBS, FOOTPATHS, AND CROSSINGS.

**Approved Plans** - Whangarei District

Council RCA –SD2200045

JF 19/12/2022

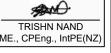

VECTA	D	FOR APPROVAL - RESPONSE TO RFI'S 2	15-12-2022 AP TN	<u> P</u>
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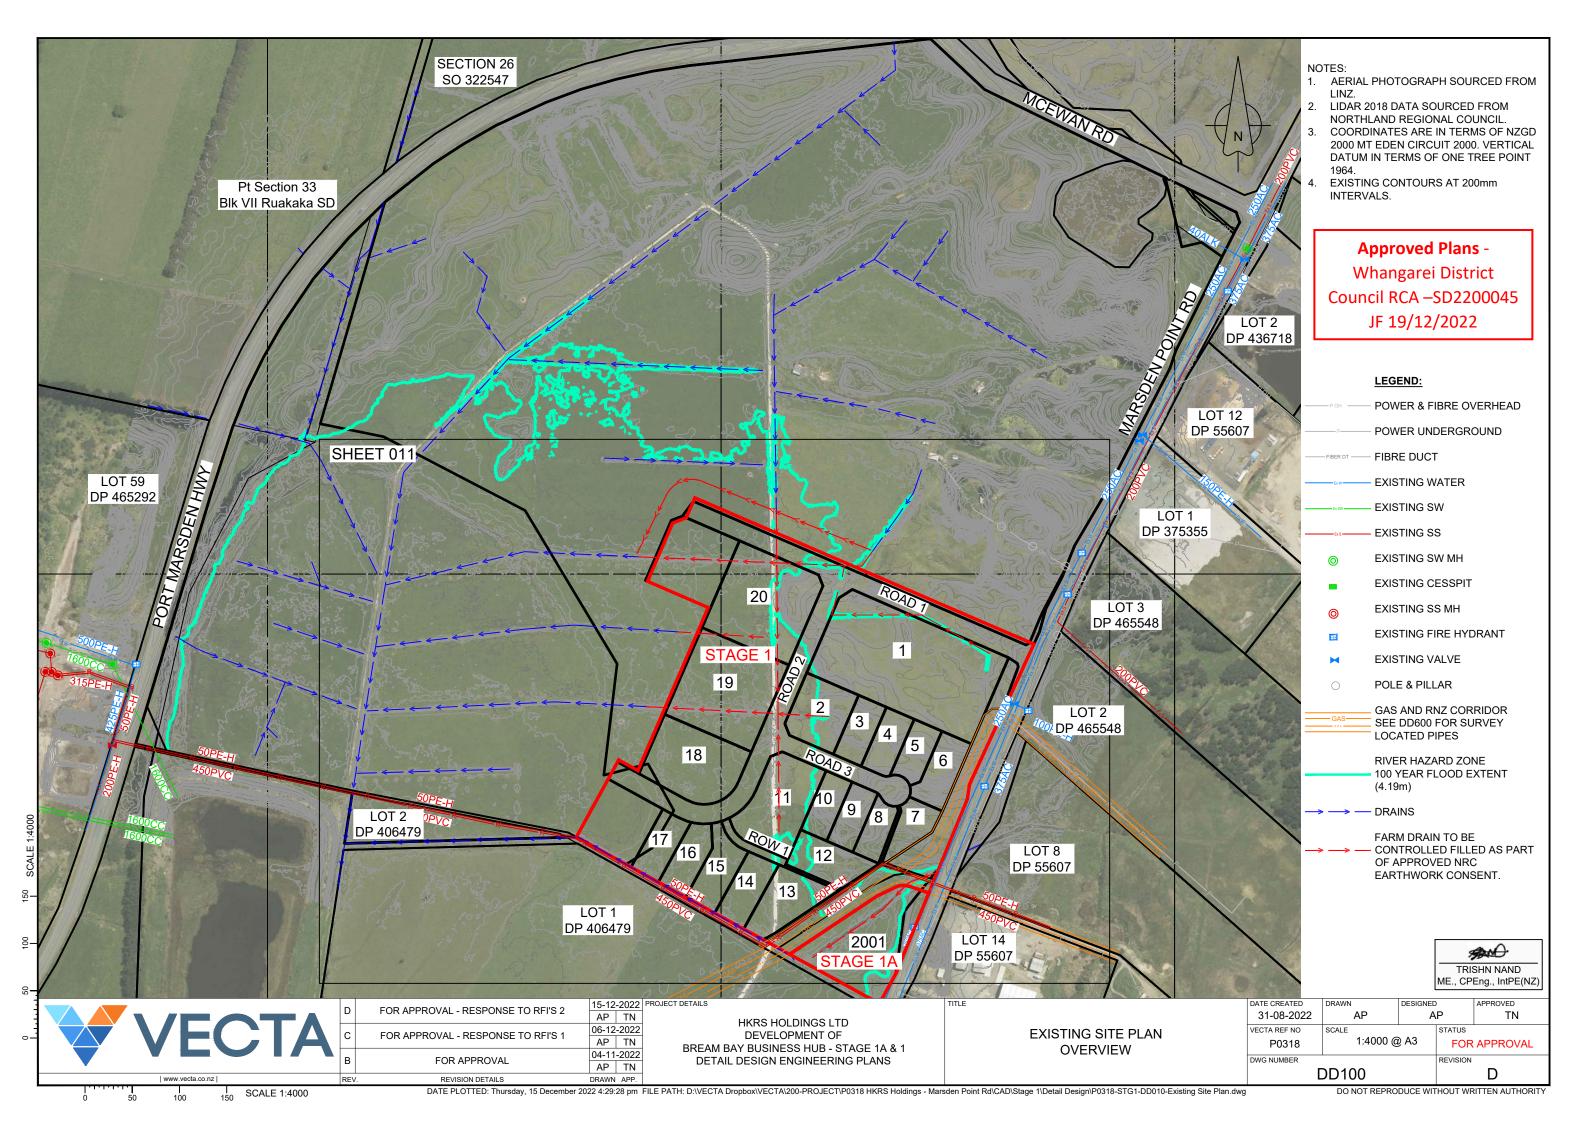
HKRS HOLDINGS LTD
DEVELOPMENT OF
BREAM BAY BUSINESS HUB - STAGE 1A & 1
DETAIL DESIGN ENGINEERING PLANS


CONSTRUCTION NOTES


DATE CREATED 31-08-2022 AP DESIGNED APPROVED TN


VECTA REF NO P0318 NTS @ A3 FOR APPROVAL


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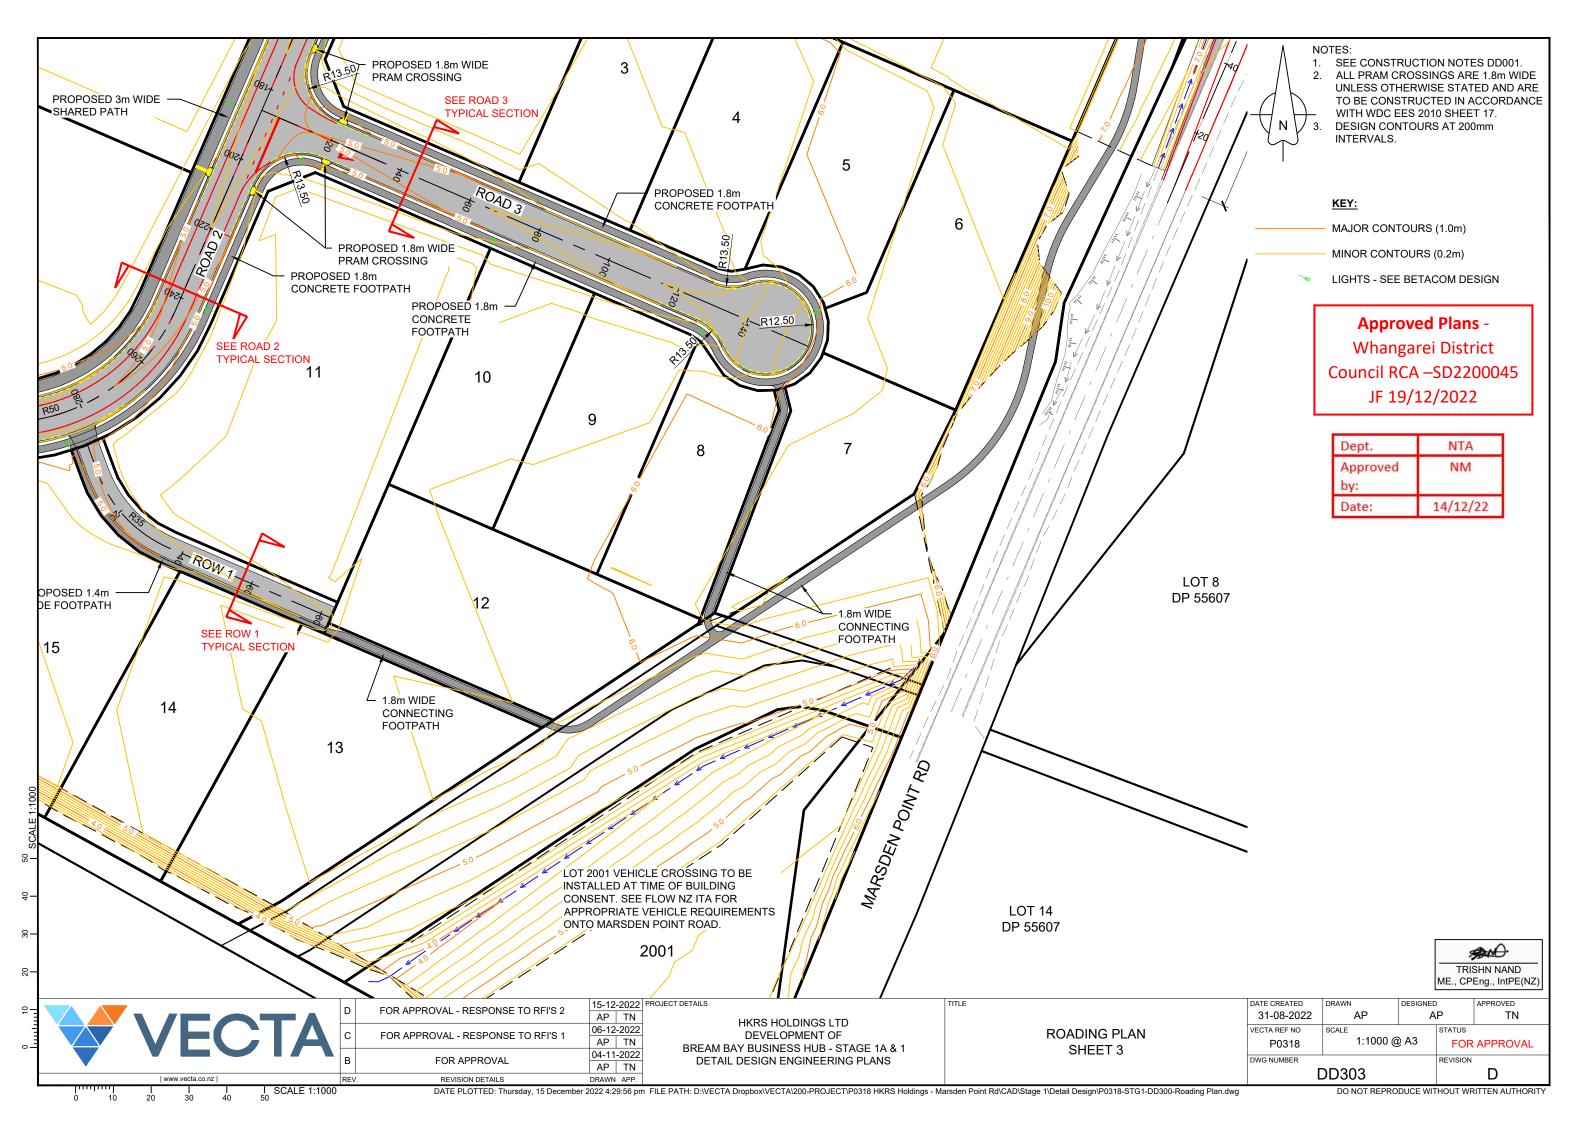





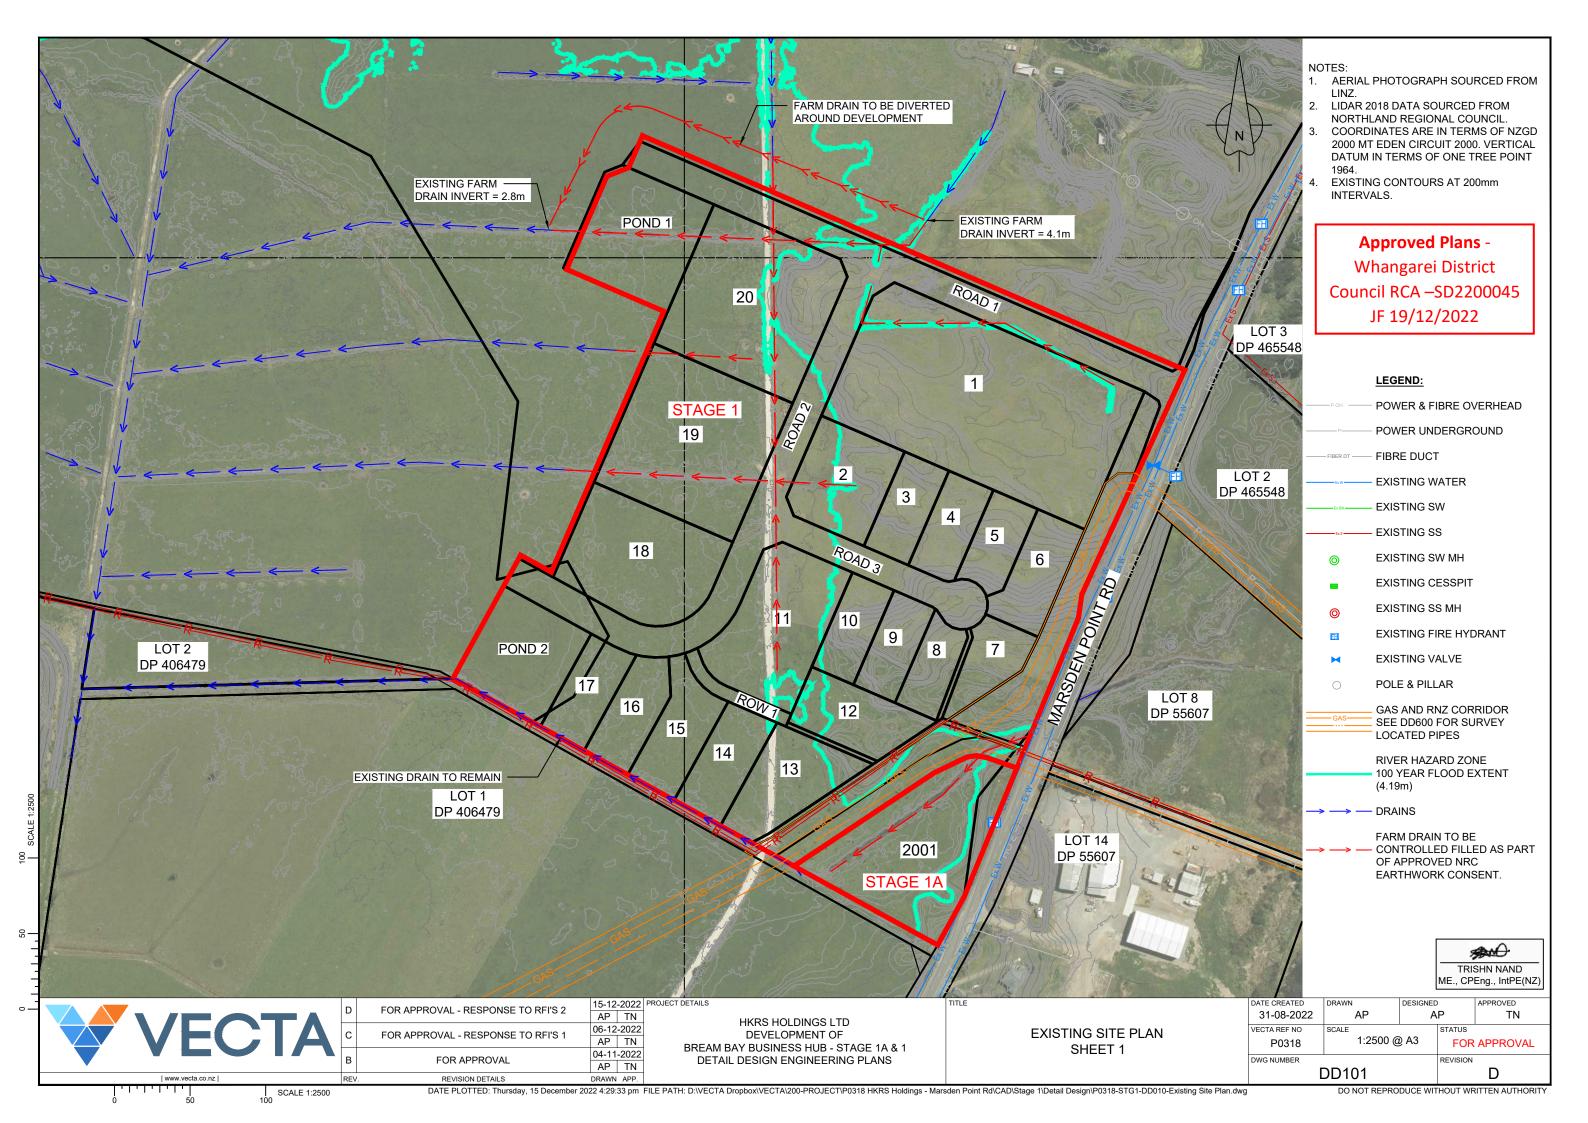


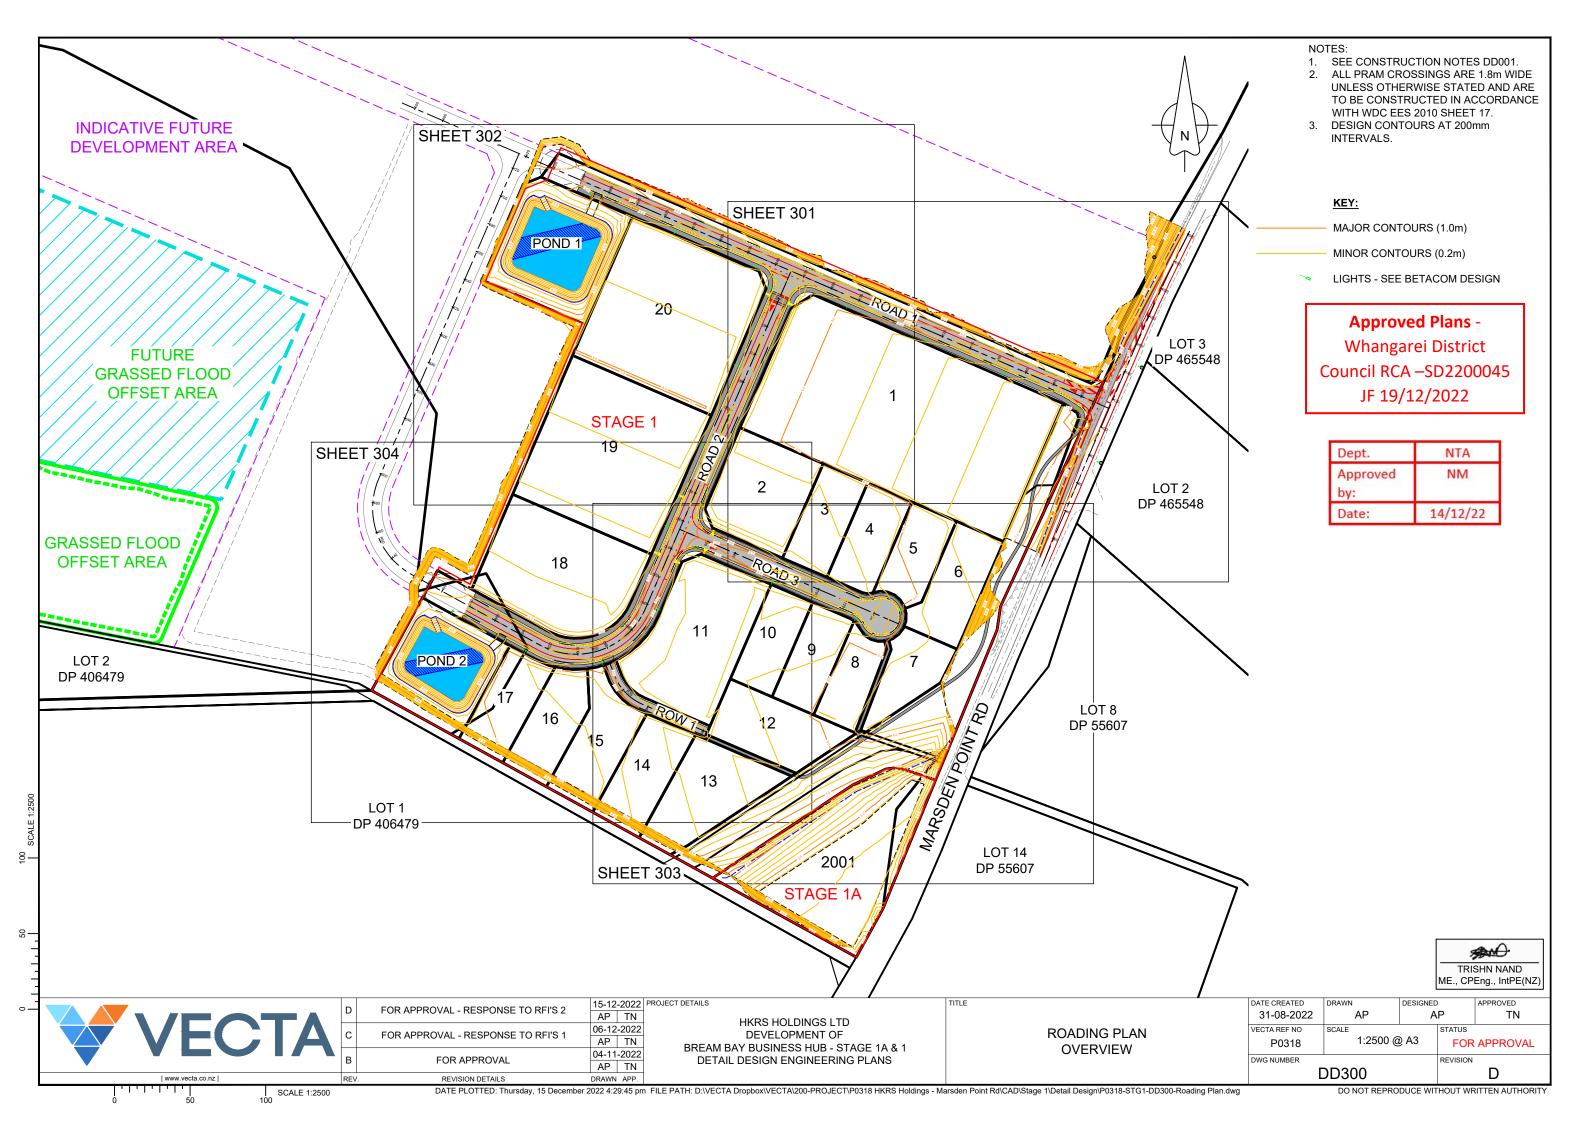


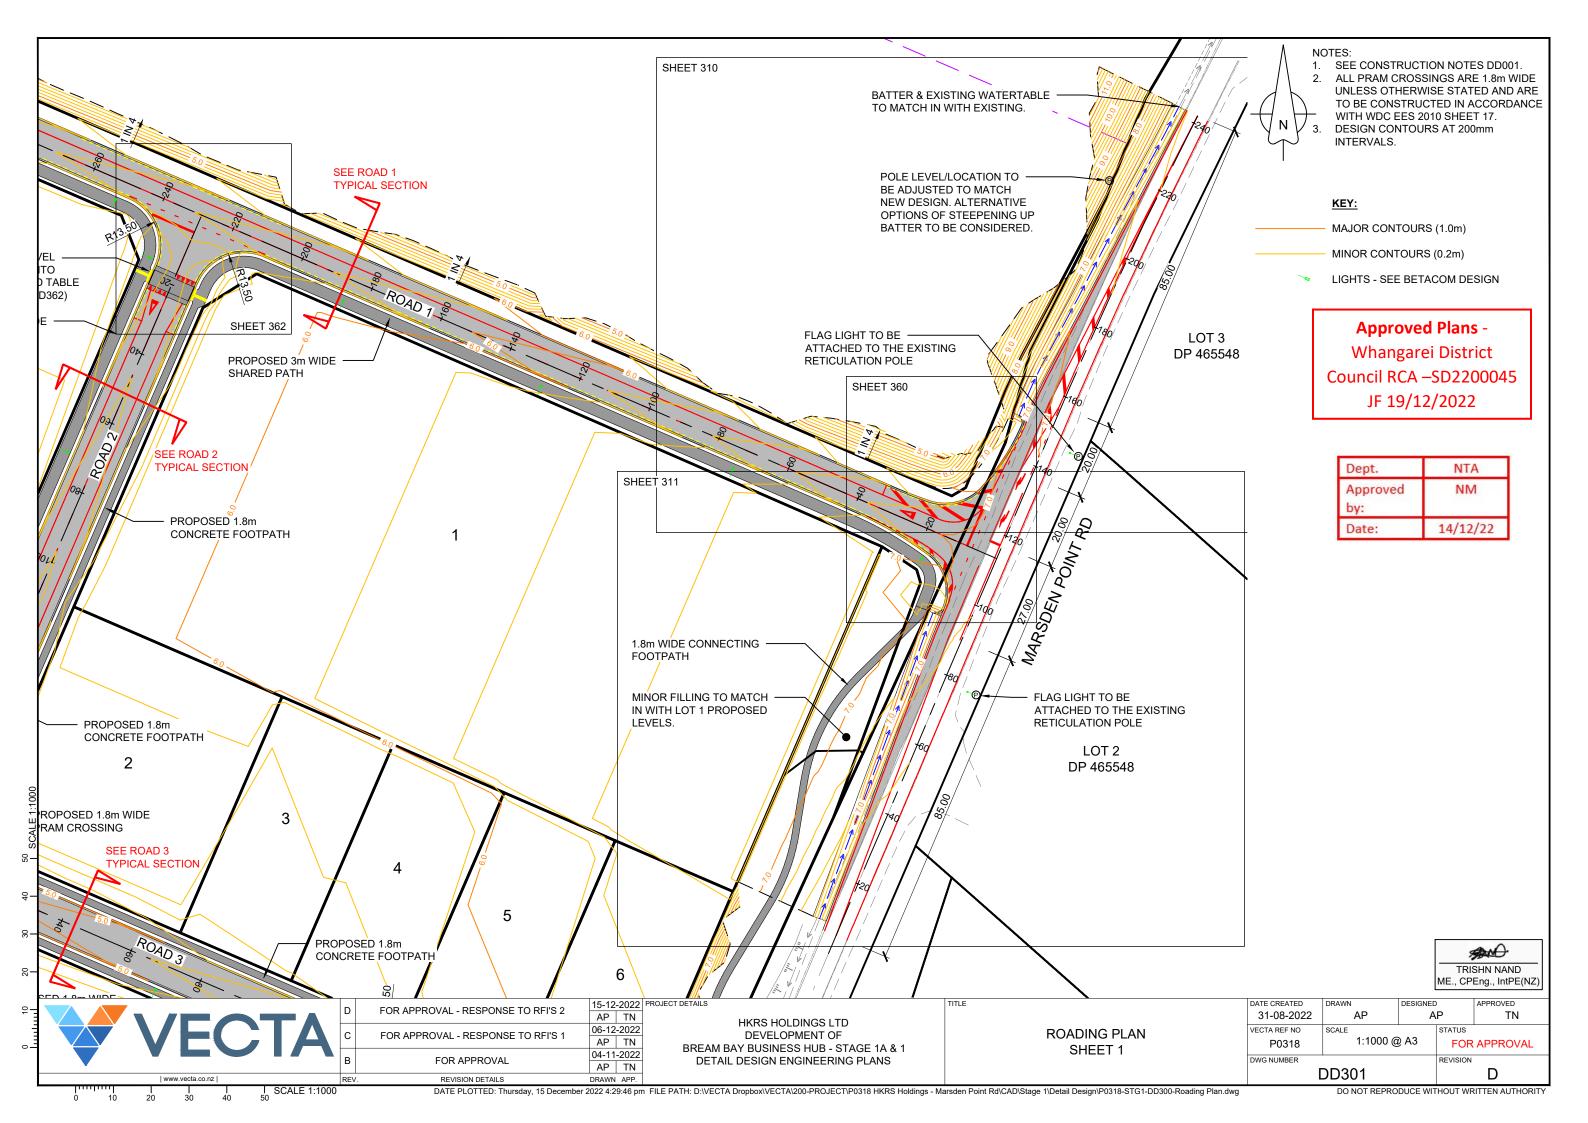


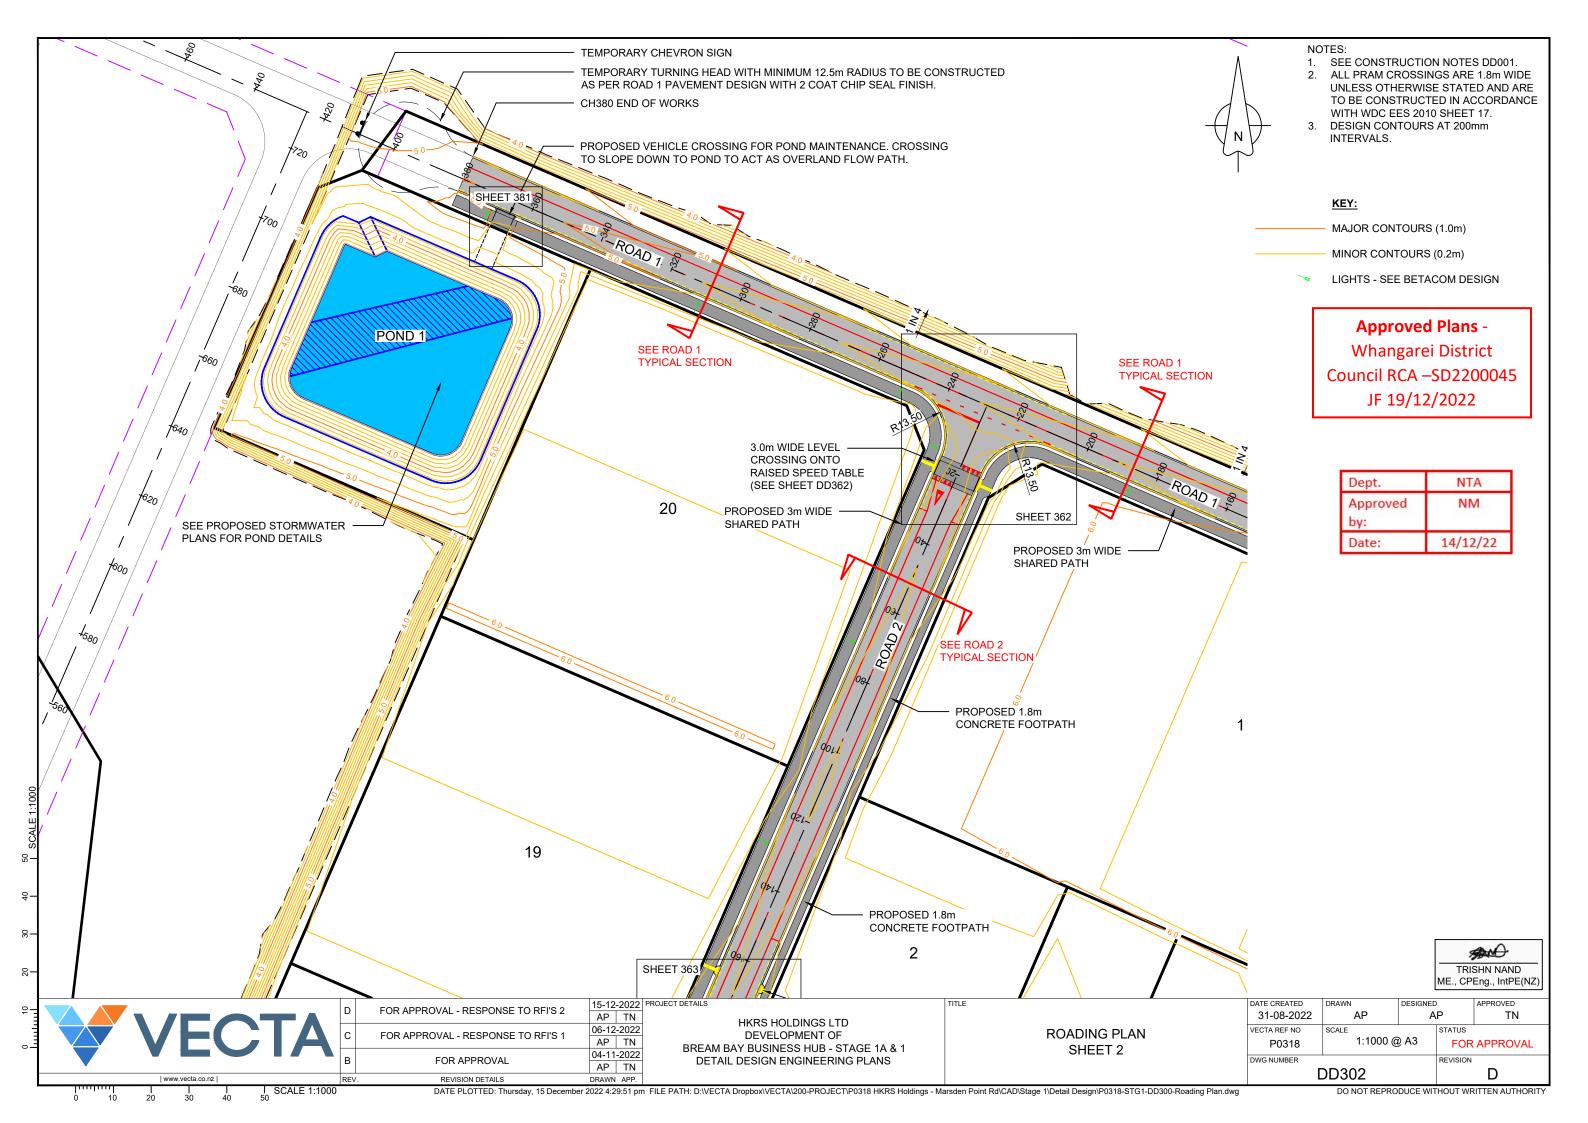


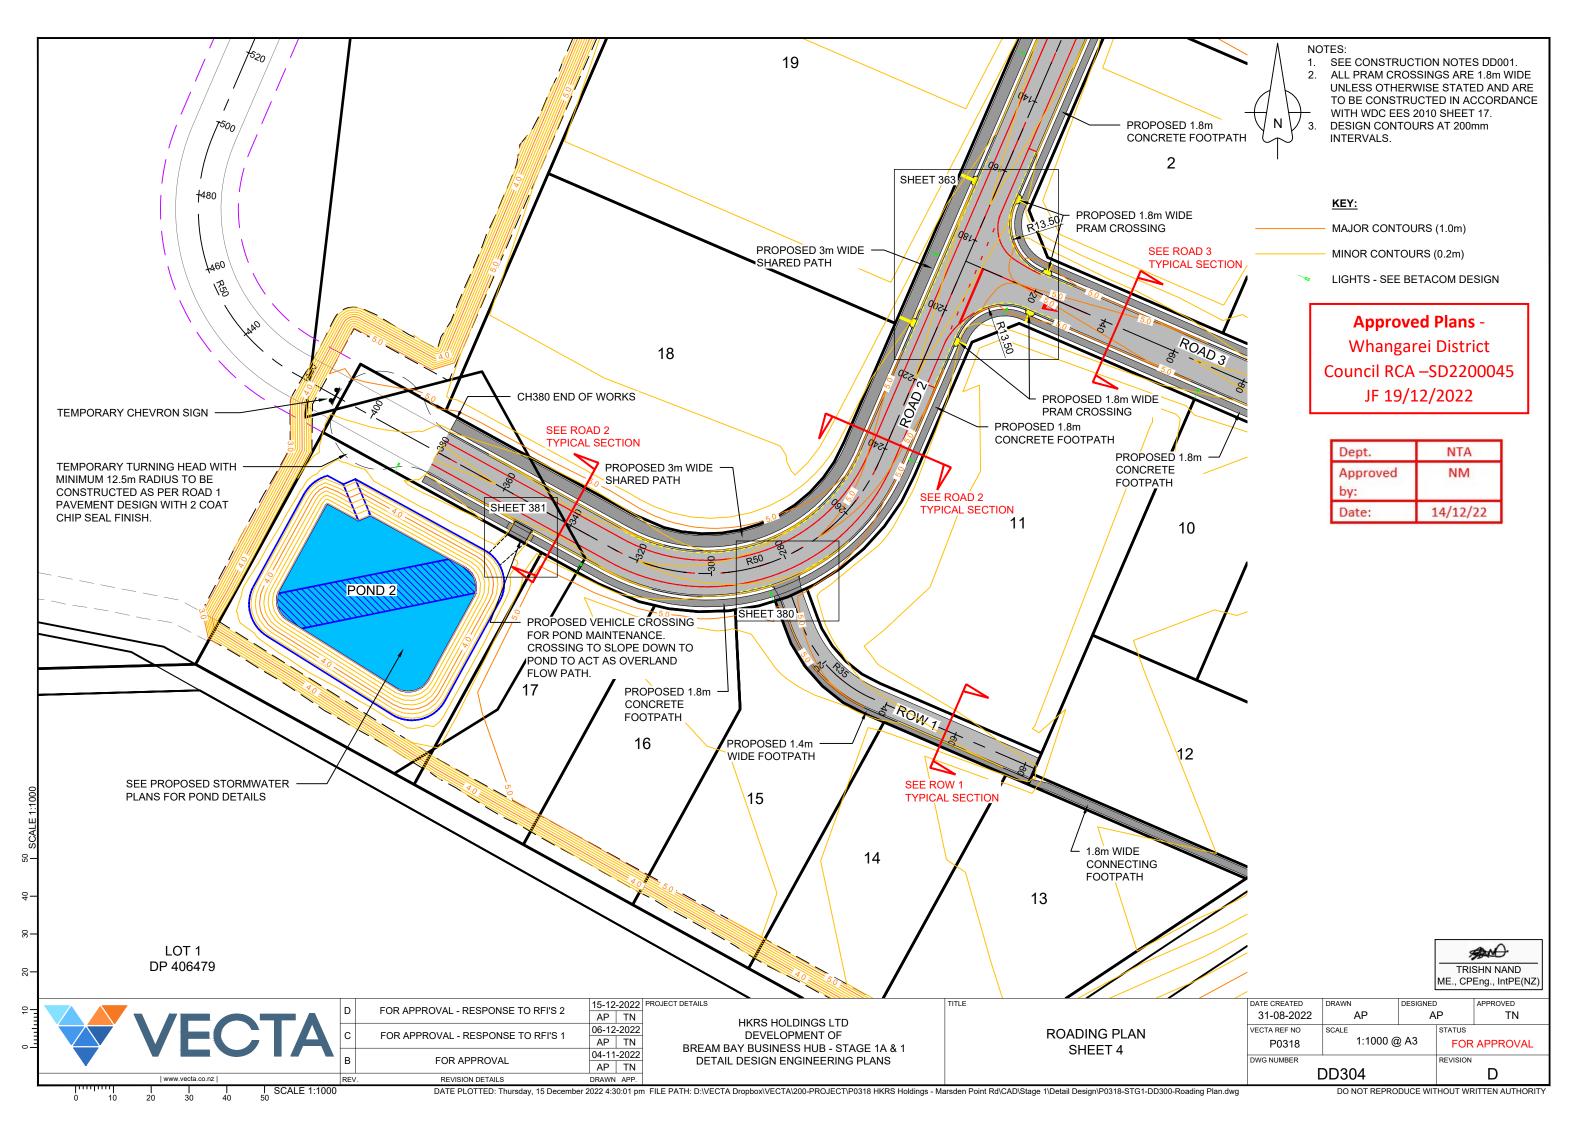


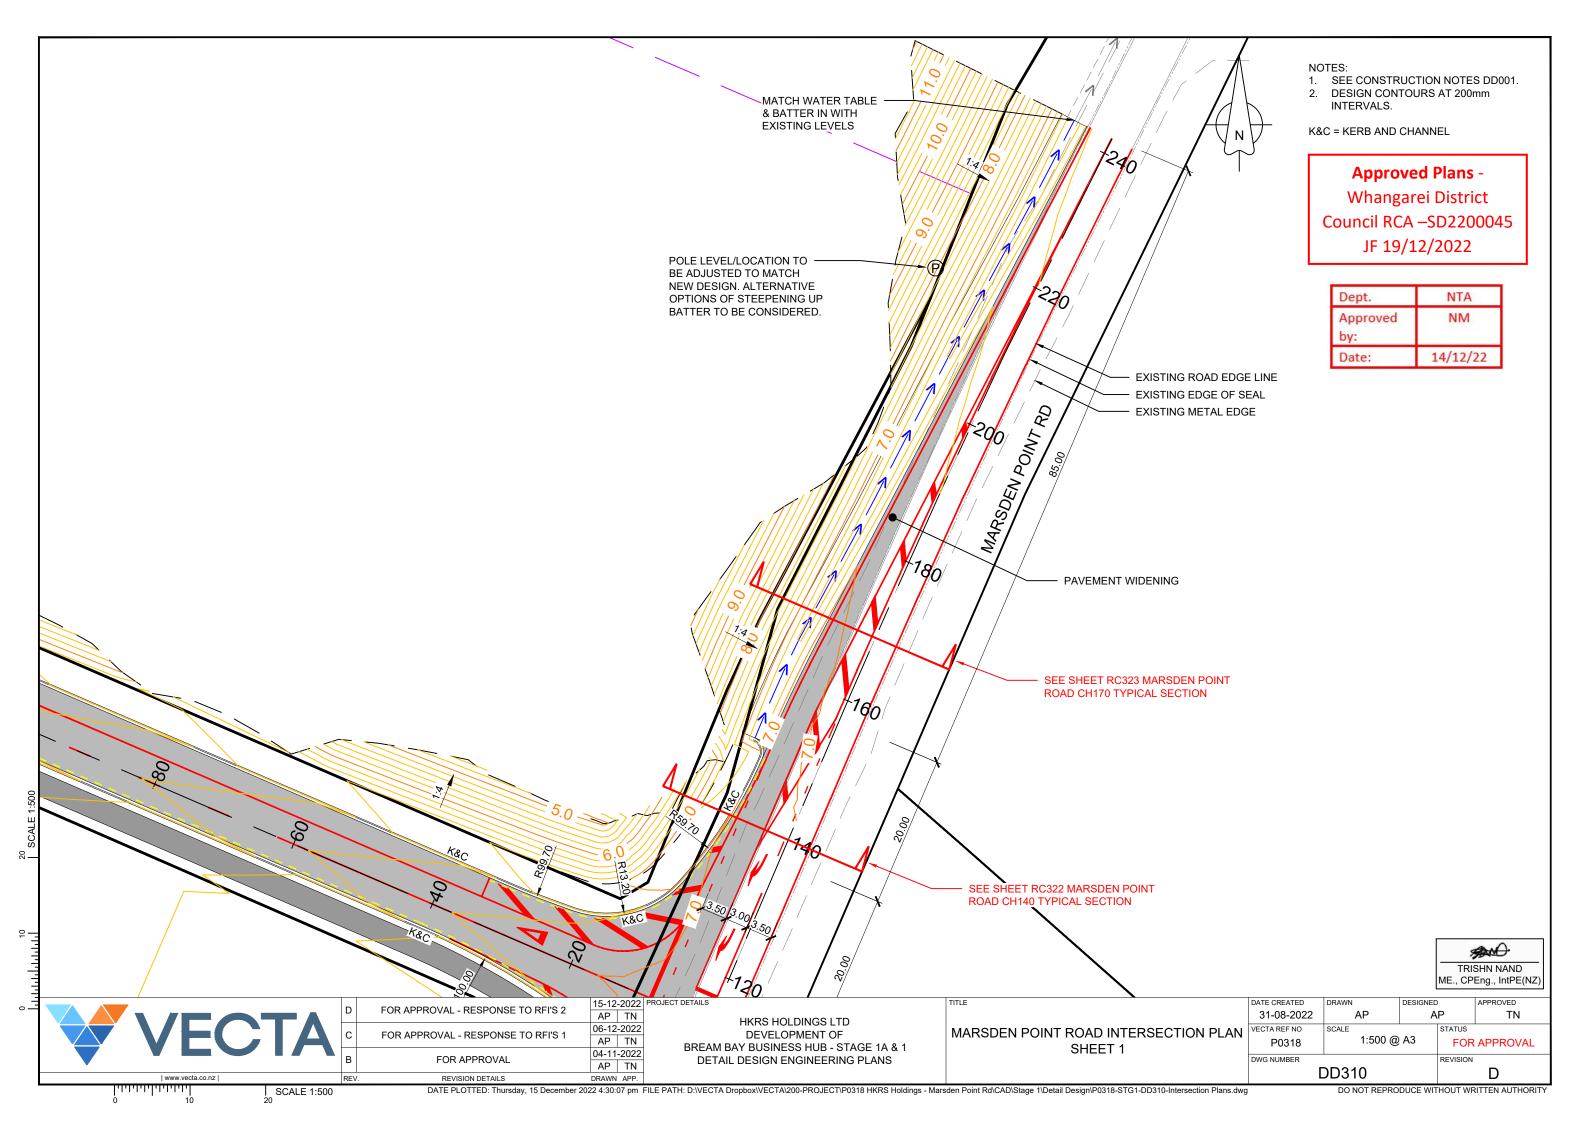

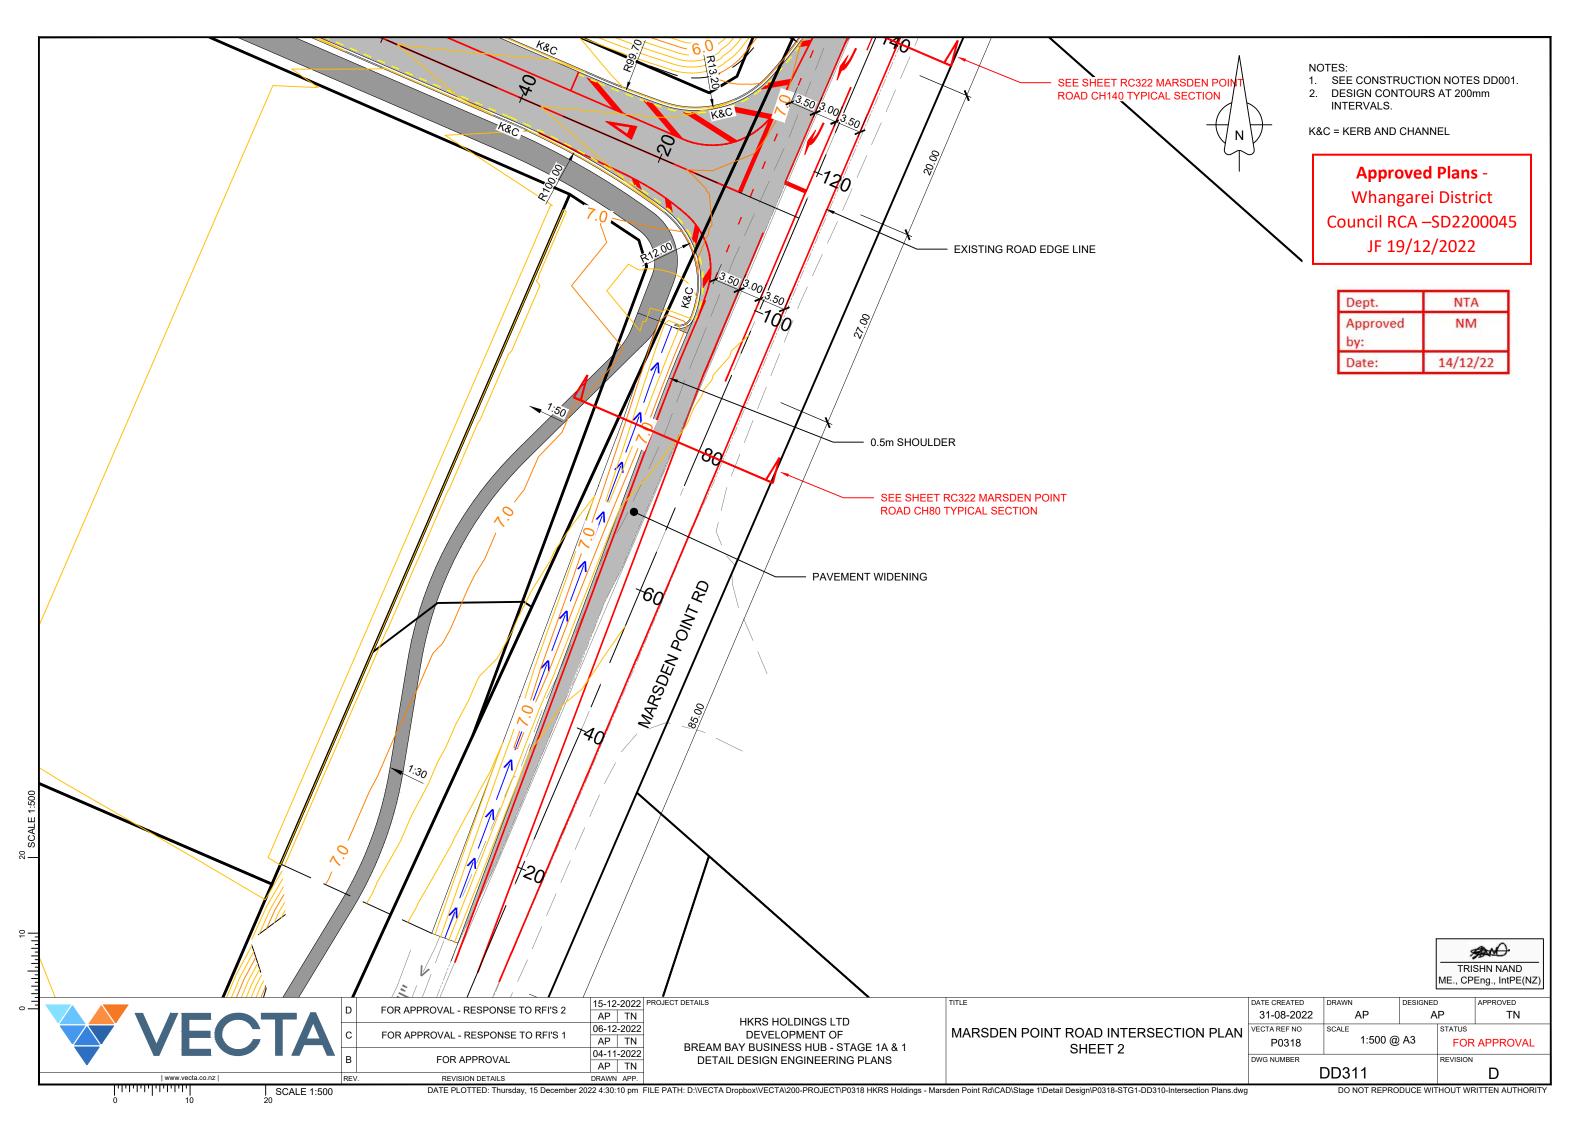

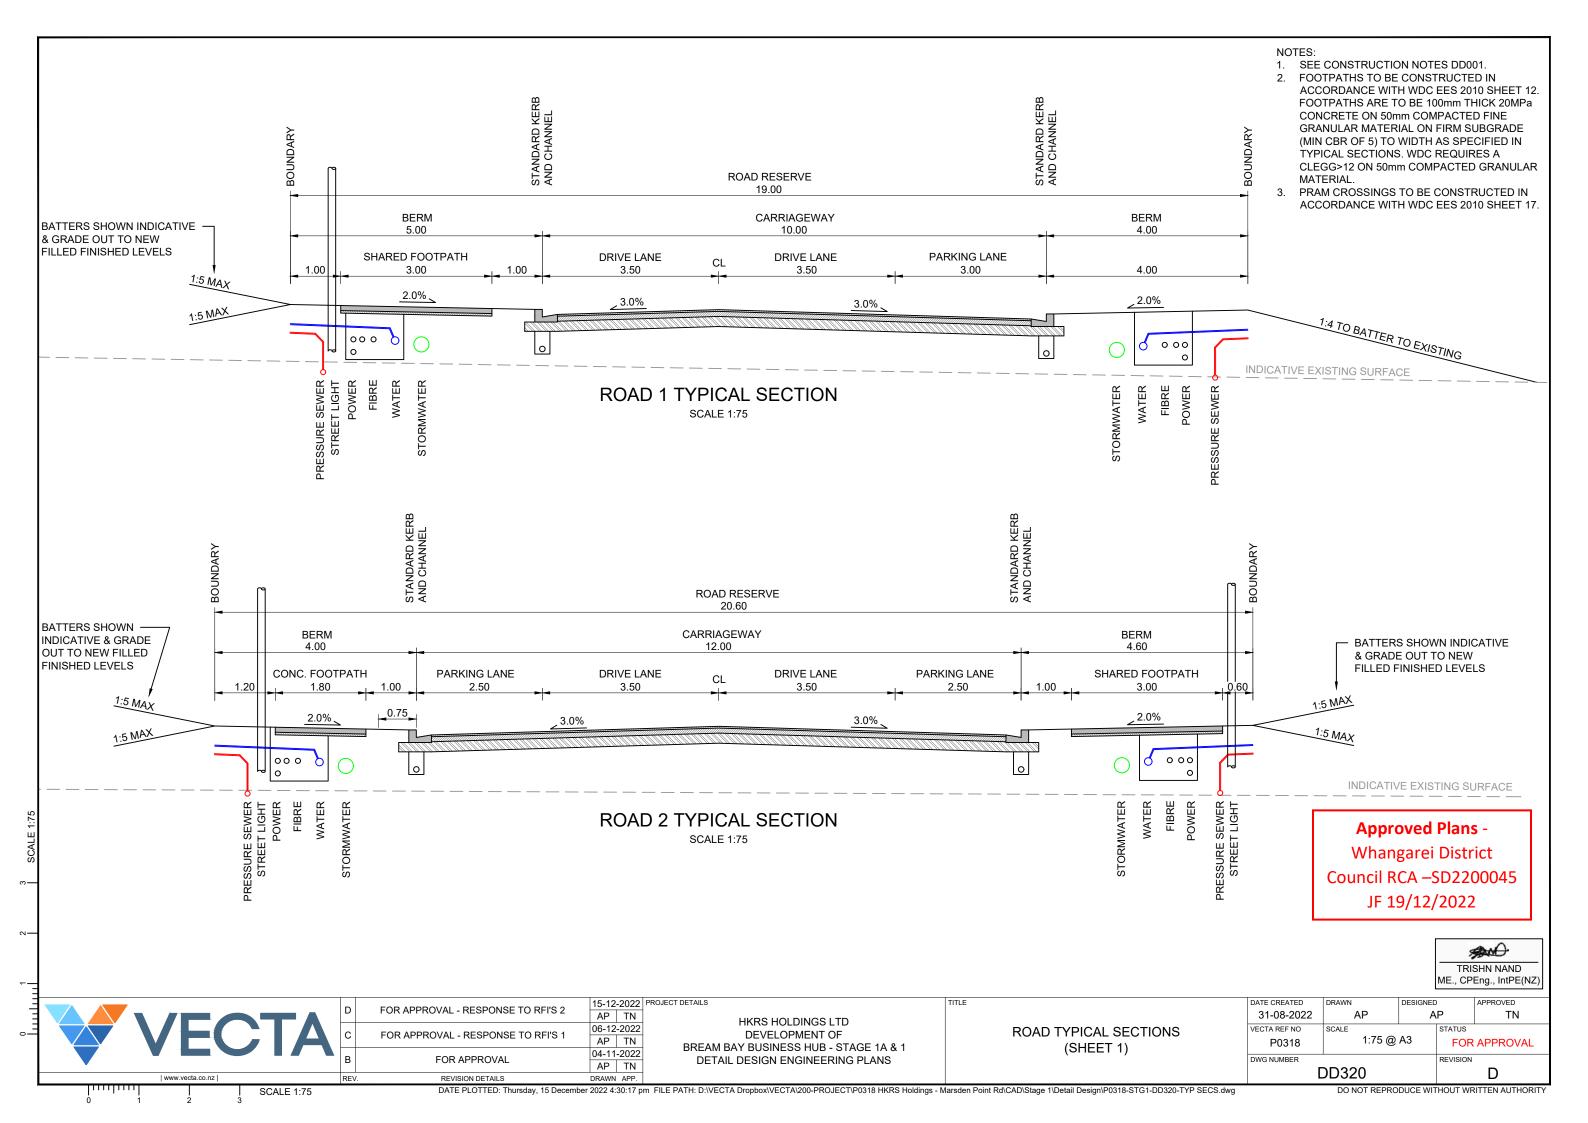

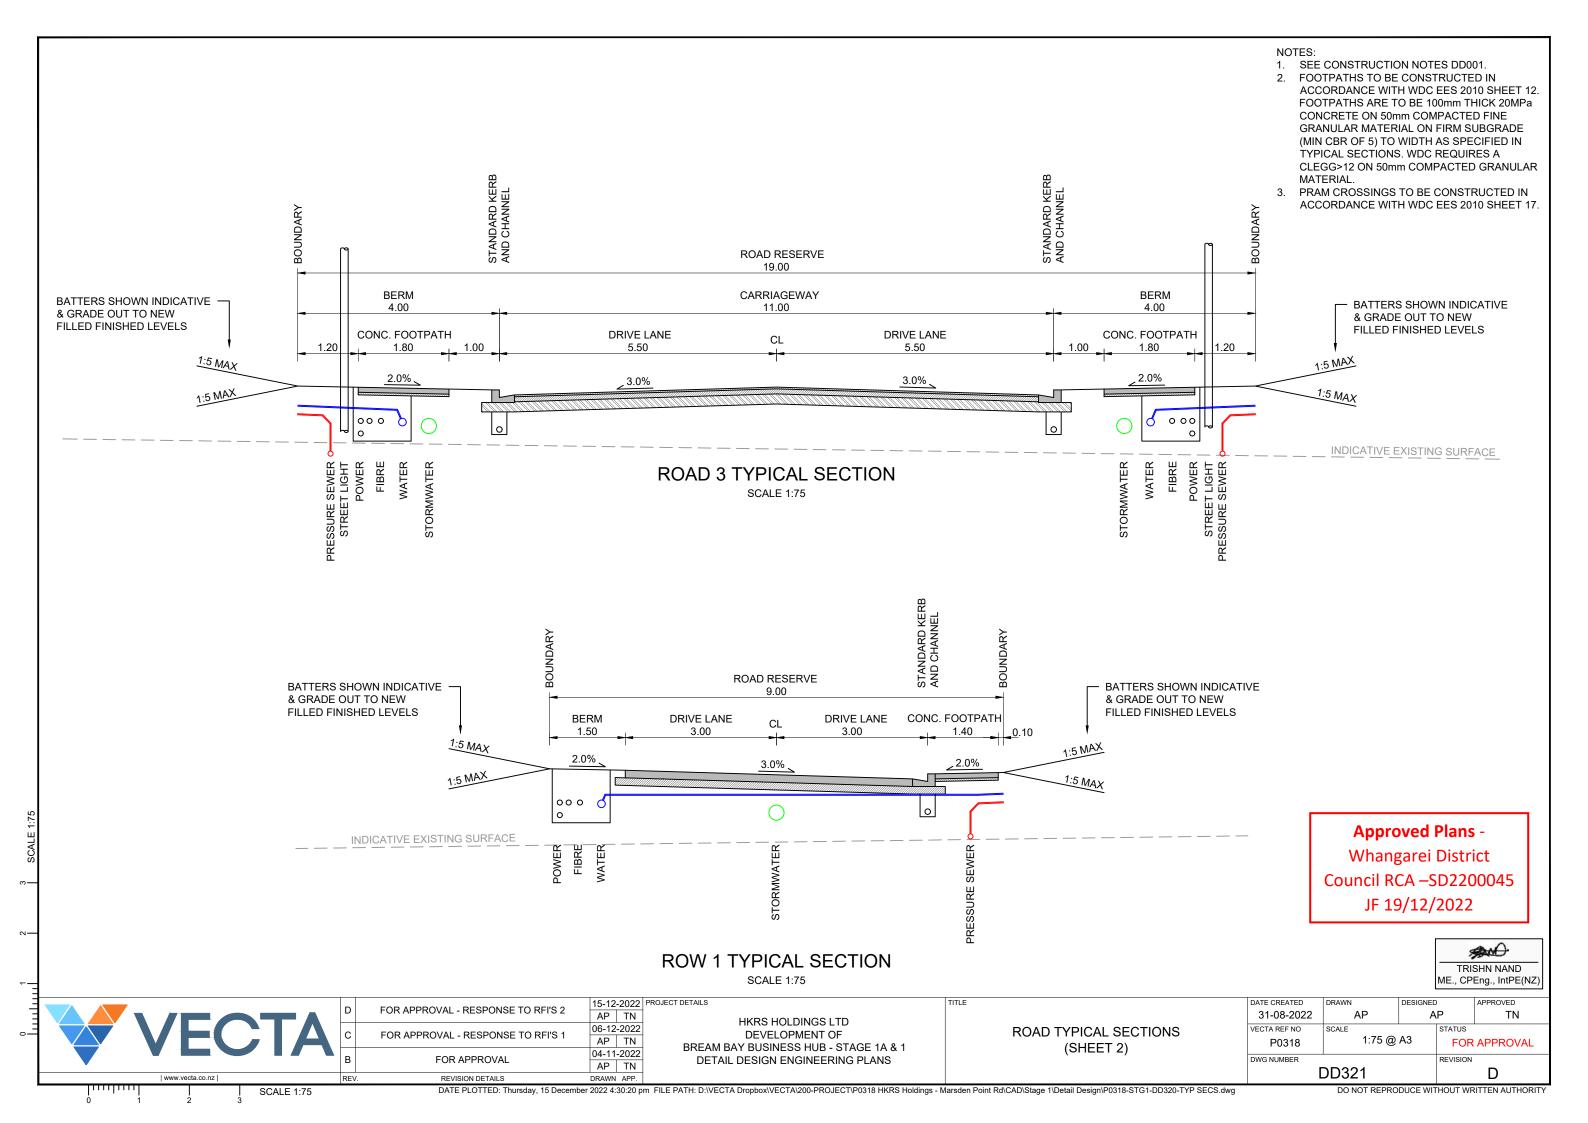

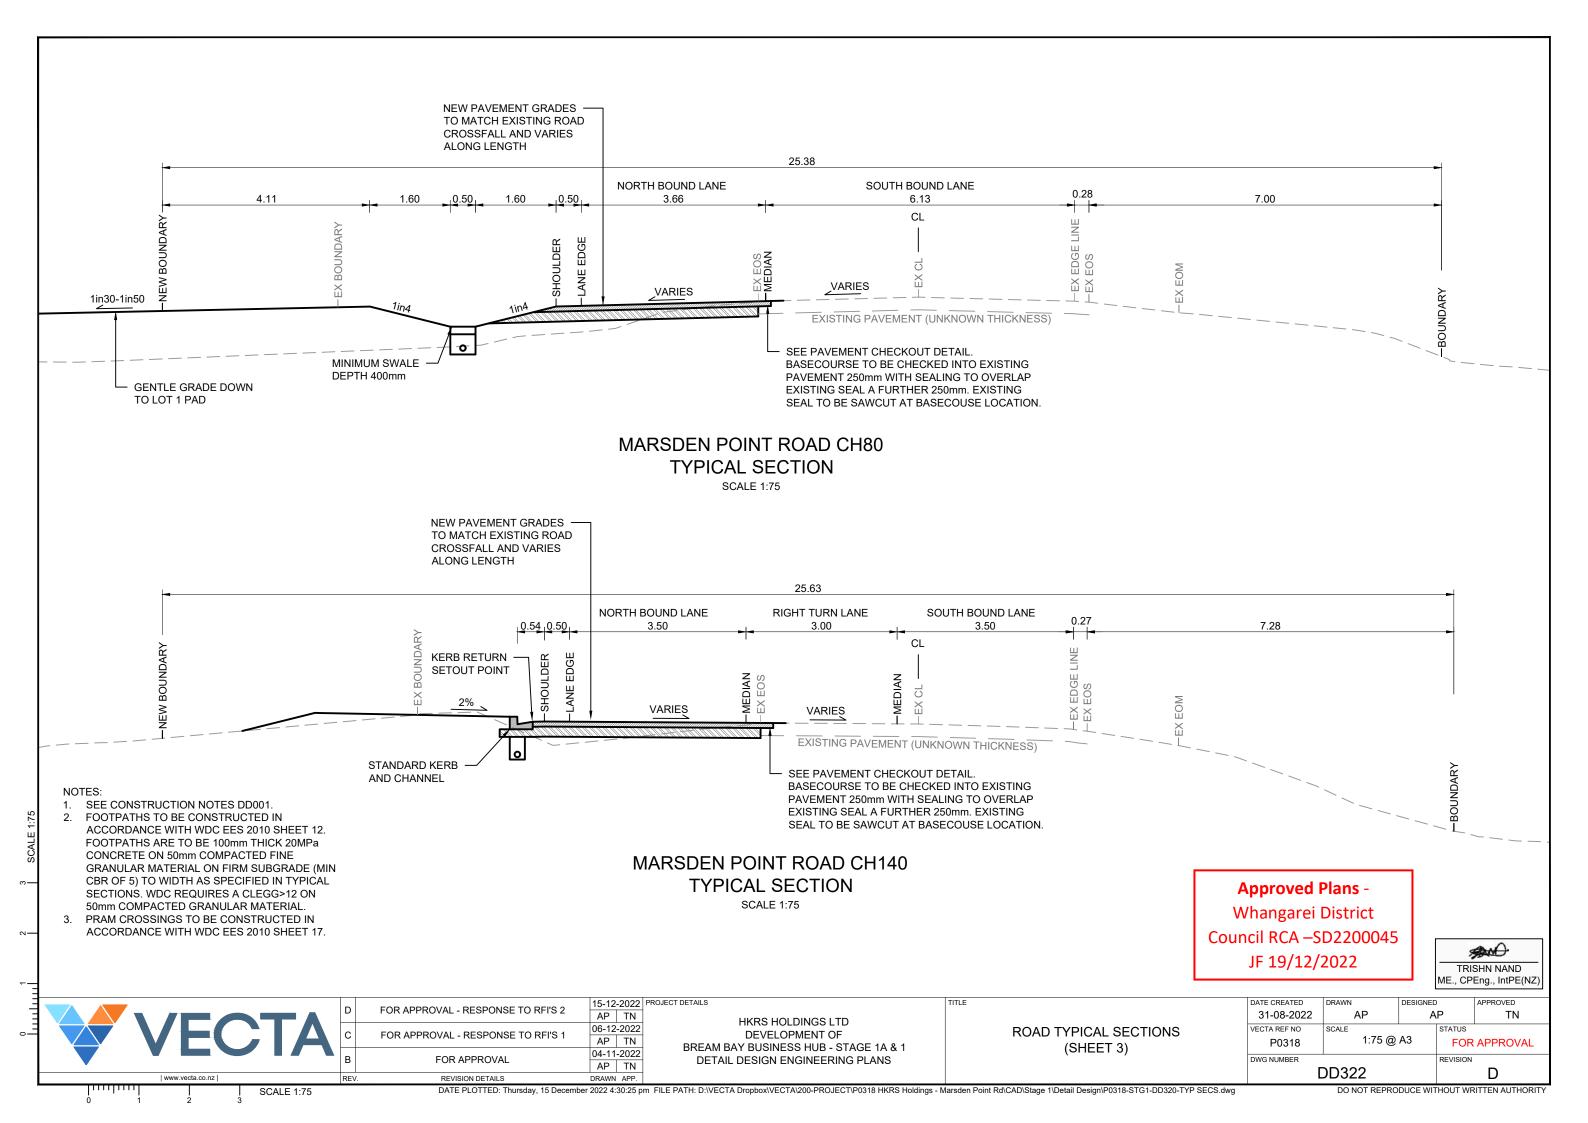

# SEE CONSTRUCTION NOTES DD001. FOOTPATHS TO BE CONSTRUCTED IN ACCORDANCE WITH WDC EES 2010 SHEET 12. FOOTPATHS ARE TO BE 100mm THICK 20MPa CONCRETE ON 50mm COMPACTED FINE GRANULAR MATERIAL ON FIRM SUBGRADE (MIN CBR OF 5) TO WIDTH AS SPECIFIED IN TYPICAL SECTIONS. WDC REQUIRES A CLEGG>12 ON 50mm COMPACTED GRANULAR MATERIAL. PRAM CROSSINGS TO BE CONSTRUCTED IN ACCORDANCE WITH WDC EES 2010 SHEET 17. NEW PAVEMENT GRADES -TO MATCH EXISTING ROAD CROSSFALL AND VARIES ALONG LENGTH 25.26 NORTH BOUND LANE RIGHT TURN TAPER SOUTH BOUND LANE 3.51 2.03 7.28 4.05 1.60-2.00 CL -MEDIAN **VARIES** VARIES EXISTING PAVEMENT (UNKNOWN THICKNESS) SEE PAVEMENT CHECKOUT DETAIL MINIMUM SWALE BASECOURSE TO BE CHECKED INTO EXISTING DEPTH 400mm PAVEMENT 250mm WITH SEALING TO OVERLAP EXISTING SEAL A FURTHER 250mm. EXISTING SEAL TO BE SAWCUT AT BASECOUSE LOCATION. MARSDEN POINT ROAD CH170 TYPICAL SECTION **SCALE 1:75 Approved Plans -**Whangarei District

Council RCA -SD2200045 JF 19/12/2022



15-12-2022 PROJECT DETAILS DATE CREATED FOR APPROVAL - RESPONSE TO RFI'S 2 AP TN 31-08-2022 HKRS HOLDINGS LTD 06-12-2022 **ROAD TYPICAL SECTIONS** VECTA REF NO FOR APPROVAL - RESPONSE TO RFI'S 1 **DEVELOPMENT OF** 1:75 @ A3 AP TN FOR APPROVAL P0318 BREAM BAY BUSINESS HUB - STAGE 1A & 1 (SHEET 4) 04-11-2022 FOR APPROVAL DETAIL DESIGN ENGINEERING PLANS AP TN **DD323** REVISION DETAILS **SCALE 1:75** 

# 55mm AC 14 HOT LAID ASPHALTIC CONCRETE (AC) TO COMPLY WITH NZTA M10 SPECIFICATION FOR DENSE GRADED ASPHALT. WATERPROOFING SEAL COAT, SINGLE COAT CHIP SEAL GRADE 5 WITH HOT BITUMEN SPRAY. 150mm COMPACTED TNZ M/4 (AP40) COMPLYING WITH TNZ M/4 SPECIFICATION IN ACCORDANCE WITH THE GRADING LIMITS SPECIFIED IN WDC EES SUBCLAUSE 3.5.1.4 BASECOURSE MATERIAL. 200mm COMPACTED GAP65 SUB-BASE IN ACCORDANCE WITH THE GRADING LIMITS SPECIFIED IN WDC EES SUBCLAUSE 3.5.1.3 SUB-BASE MATERIAL. 180mm SELECT HARD FILL CBR 15% MINIMUM.

# MARSDEN POINT ROAD, ROAD 01 & 02 PAVEMENT DETAILS

55mm AC 14 HOT LAID ASPHALTIC CONCRETE (AC) TO COMPLY WITH NZTA M10 SPECIFICATION FOR DENSE GRADED ASPHALT.

WATERPROOFING SEAL COAT, SINGLE COAT CHIP SEAL GRADE 5 WITH HOT BITUMEN SPRAY.

150mm COMPACTED TNZ M/4 (AP40) COMPLYING WITH TNZ M/4 SPECIFICATION IN ACCORDANCE WITH THE GRADING LIMITS SPECIFIED IN WDC EES SUBCLAUSE 3.5.1.4 BASECOURSE MATERIAL


 150mm COMPACTED GAP65 SUB-BASE IN ACCORDANCE WITH THE GRADING LIMITS SPECIFIED IN WDC EES SUBCLAUSE 3.5.1.3 SUB-BASE MATERIAL.

- 180mm SELECT HARD FILL CBR 15% MINIMUM.

 COMPACTED SUBGRADE WITH CBR > 7%. DESIGN CBR TO BE CONFIRMED FOLLOWING FORMATION EARTHWORKS TO SUBGRADE LEVELS.

### **ROAD 03 PAVEMENT DETAILS**

SCALE 1:10

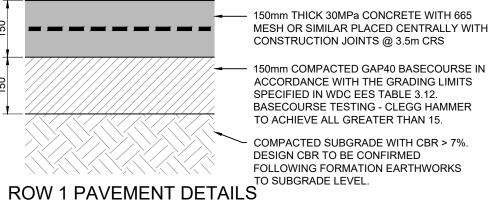

I PAVEIVILINI DETAILS

SCALE 1:10

#### 

PAVEMENT TESTING REQUIREMENTS ROAD 01, 02, 03 & MPR

SURFACE TESTING - BENKELMAN BEAM AT 10m CENTRES (STAGGERED) IN THE WHEEL TRACK IN BOTH LANES WITH: ROAD 1, 2 AND MPR ACHIEVING MAX95TH PERCENTILE DO DEFLECTION OF 0.70mm WITH MAX 95TH PERCENTILE CURVATURE D0-D200 OF 0.15mm; & ROAD 3 ACHIEVING MAX95TH PERCENTILE D0 DEFLECTION

& ROAD 3 ACHIEVING MAX95TH PERCENTILE D0 DEFLECTION OF 1.00mm WITH MAX95TH PERCENTILE CURVATURE OF D0-D200 OF 0.17mm.

BASECOURSE TESTING - NUCLEAR DENSOMETER IN ACCORDANCE WITH NZS4407 TEST 4.2.2 TO ACHIEVE MAXIMUM DRY DENSITY OF ≥95% MINIMUM AND ≥98% MEAN AS PER TNZ B/2. CLEGG HAMMER AT 20m CENTRES AT THE EDGES AND CENTRE OF PAVEMENTS TO ACHIEVE CLEGG 40 FOR NOT LESS THAN 90% OF THE SURFACE TESTED AND NO VALUE LESS THAN 35.

SUBBASE TESTING - NUCLEAR DENSOMETER IN ACCORDANCE WITH NZS4407 TEST 4.2.2 TO ACHIEVE MAXIMUM DRY DENSITY OF  $\geq$ 92% MINIMUM AND  $\geq$ 95% MEAN AS PER TNZ B/2.


SELECT HARD FILL TESTING - GEOTECHNICAL ENGINEER TO CONFIRM CBR OF 15% ACHIEVED

SUBGRADE CBR OF 7 (FIRST 600mm DEEP) - TO ACHIEVE 30mm/BLOW WITH SCALA PENETROMETER.

Approved Plans Whangarei District
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JF 19/12/2022


#### NOTES

- 1. SEE CONSTRUCTION NOTES DD001.
- CLEGG >15 REQUIRED UNDER ALL KERBS BY WDC.

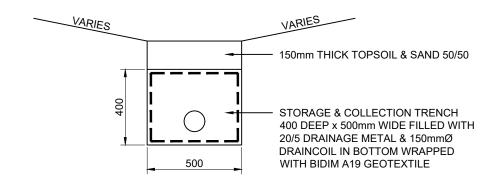


# SWALE SUBSOIL DRAIN

NOT TO SCALE

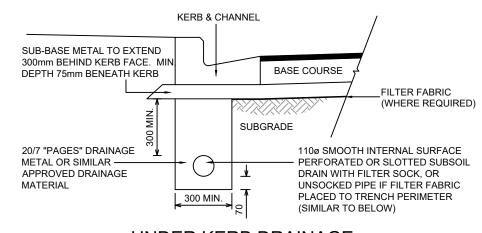

# **UNDER KERB DRAINAGE**

SHEET 14 WDC EES 2010 - NOT TO SCALE

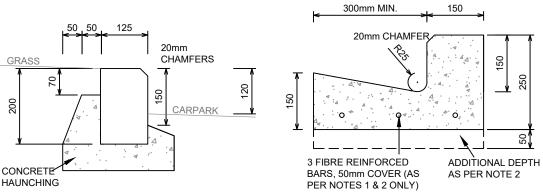

#### UPRIGHT KERB BLOCK DETAIL

SCALE SHEET 13 WDC EES 2010 - NOT TO SCALE

#### KERB NOTES

- 3/FIBRE REINFORCING BARS TO BE PLACED AROUND ALL CURVES, AND INTERSECTIONS BETWEEN TANGENT POINTS IN BUSINESS ENVIRONMENTS.
- COMMERCIAL & INDUSTRIAL CROSSINGS TO BE ADDITIONAL 50mm IN DEPTH AS WELL AS HAVING 3-FIBRE REINFORCED BARS EQUALLY SPACED IN THE CHANNEL.
- CONCRETE FOR DISHED CHANNEL, PRAM CROSSING, STANDARD KERB AND CHANNEL AND MOUNTABLE KERB AND CHANNEL & FLUSH EDGE BEAM SHALL BE 30MPa AT 28 DAYS.
- CRACK CONTROL JOINTS TO BE FORMED AT MAXIMUM OF 3.5 METRE INTERVALS. TO BE A MINIMUM DEPTH OF 30mm.
   PROFILES MAY BE MODIFIED SLIGHTLY TO SUIT KERBING
- 6. KERB BLOCKS HAUNCHING TO BE 20MPa AT 28 DAYS.



FOR APPROVAL

TN

HKRS HOLDINGS LTD
DEVELOPMENT OF
BREAM BAY BUSINESS HUB - STAGE 1A & 1
DETAIL DESIGN ENGINEERING PLANS

PAVEMENT AND KERB DETAILS

PAVEMENT AND KERB DETAILS

PO318


SCALE
AS SHOWN @ A3

DWG NUMBER

DD325

KERB AND CHANNEL

ΑP

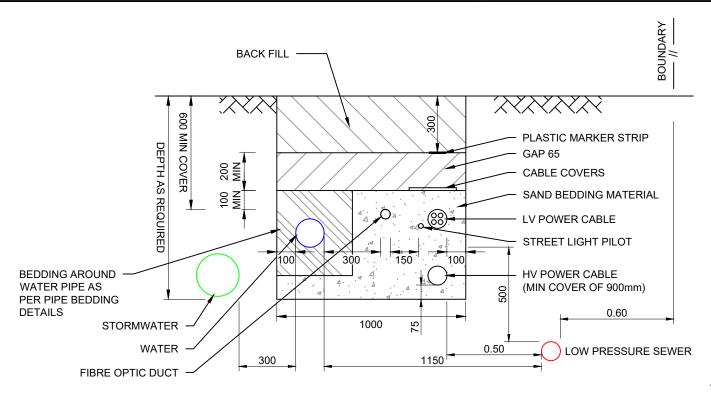

COMBINED SERVICE TRENCH

LV POWER CABLE TRENCH

THE MINIMUM CLEAR DISTANCE BETWEEN SERVICES SHALL BE THE GREATER OF THE REQUIRED CLEARANCES BETWEEN THE RELEVANT SERVICES AS FOLLOWS:

STORMWATER: 300 H, 150 V

WASTERWATER: 300 H, 150 V (EXCEPT WATERMAINS AS FOLLOWS)

1000 H, 500 V OR 600 H, 750 V TO WASTEWATERS AS PER TABLE 5.7.

ELECTRICITY: 500 H, 225 V (EXCEPT WATERMAINS > 200mm ID AS FOLLOWS)

1000 H, 225 V TO WATERMAINS > 200mm ID.

TELECOM & GAS: 300 H, 150 V (EXCEPT WATERMAINS > 200mm ID AS FOLLOWS)

600 H, 150 V TO WATERMAINS > 200mm ID.

WATERMAINS: CLEARANCE TO OTHER SERVICES AS ABOVE.

CLEARANCE TO OTHER WATERMAINS AS FOLLOWS: 600 H, 500 V WHERE NEW PIPELINE IS > 375mm ID 300 H, 150 V WHERE NEW PIPELINE IS  $\leq$  200mm ID

AND WHERE EXISTING PIPELINE IS≤375mm ID

600 H, 150 V WHERE NEW PIPELINE IS > 200mm ID

AND WHERE EXISTING PIPELINE IS < 375mm ID

#### NOTES:

- . ALL DISTANCES IN MM.
- 2. ALL SERVICES SHALL HAVE 600mm MIN. COVER UNDER FOOTPATHS AND BERMS.
- 3. REFER TO TABLE 5.7 (WASTEWATER) AND 6.4 (WATER) FOR FURTHER NOTES.
- 4. VERTICAL CLEARANCES APPLY WHERE SERVICES CROSS, EXCEPT THAT WATERMAINS SHALL ALWAYS MAINTAIN A CLEARANCE ABOVE A PARALLEL WASTEWATER PIPELINE.

# MINIMUM CLEARANCES BETWEEN SERVICES

FOR LIVING 1 AND 2 AND ALL BUSINESS ENVIRONMENTS WDC EES 2010 SHEET 30

#### NOTES:


- BEDDING MATERIAL EITHER SAND OR 'CLEAN' SOIL.
   THERMAL BACKFILL TO BE USED WHERE SPECIFIED
- . COVERS TO COMPLY WITH AS/NZS 3000:2000 3.11.3.3 AND AS4705-2000 AND SHALL BE LOCATED 75mm ABOVE CABLES AND DUCTS. CABLE COVERS SHALL BE AT LEAST 150mm IN WIDTH AND OVERLAP AT LEAST 40mm EACH SIDE OF THE CABLE.
- 3. BACKFILL, GENERALLY USE FILL FROM TRENCH BUT ENSURE NO LARGE STONES OR SHARP OBJECTS ARE PLACED BACK IN THE TRENCH.
- MARKER STRIP TO COMPLY WITH AS/NZS 3000:2000 3.11.3.4 AND BE 100mm WIDE, COLOURED ORANGE, WITH THE WORDS 'ELECTRICAL CABLE BELOW'.
- 5. WHERE PRACTICAL PROVIDE SOME SEPARATION (75mm OR GREATER)
  BETWEEN DIRECT LAID LV AND SL CABLE / FIBRE OPTIC DUCT.

# DIRECTLY LAID LV CABLES

NORTHPOWER SHEET 2F250s7

# **DETECTION/WARNING TAPE**

- 1. A DETECTION TAPE SHALL BE LAID DIRECTLY ABOVE ALL RISING MAINS AND ABOVE NEW SEWERS. THE TAPE SHALL HAVE 'SEWERAGE' WRITTEN ON IT IN WHITE AND BE LOCATED AT A DEPTH OF 200-250mm ABOVE THE PIPE CREST. WHERE THE PIPE IS NOT LAID IN A STRAIGHT LINE BETWEEN MANHOLES, THE TAPE SHALL CONTAIN SUFFICIENT METAL TO BE DETECTABLE FROM THE SURFACE BY A STANDARD METAL DETECTOR.
- 2. A METALLIC DETECTION TAPE AND TRACER CABLE SHALL BE LAID DIRECTLY ABOVE ALL NEW NON-METALLIC WATER MAINS INCLUDING RIDER MAINS. DETECTION TAPE SHALL HAVE 'WATER' WRITTEN ON IT IN BLUE, BE LOCATED AT A DEPTH OF 200-250mm BELOW THE FINISHED SURFACE LEVEL, AND CONTAIN SUFFICIENT METAL TO BE DETECTABLE FROM THE SURFACE BY A STANDARD METAL DETECTOR. TRACER CABLE SHALL ALSO BE ATTACHED TO ALL PRINCIPAL MAINS AND RIDER MAINS. THIS WIRE SHALL TAKE THE FORM OF A CONTINUOUS 2.5mm² MULTI-STRAND (POLYTHENE SLEEVED) CABLE, STRAPPED TO THE PIPE WALL BY MEANS OF A MINIMUM OF TWO COMPLETE WRAPS OF HEAVY DUTY ADHESIVE TAPE, AT A MAXIMUM OF 3m INTERVALS. THE TRACER CABLE SHALL BE CONNECTED TO ALL SURFACE BOXES, AND ELECTRICALLY TESTED FOR CONTINUITY BY A REGISTERED ELECTRICIAN FOLLOWING INSTALLATION AND BACKFILLING. RECORDS OF THE ELECTRICAL CONTINUITY TEST SHALL BE PROVIDED BY THE CONTRACTOR.

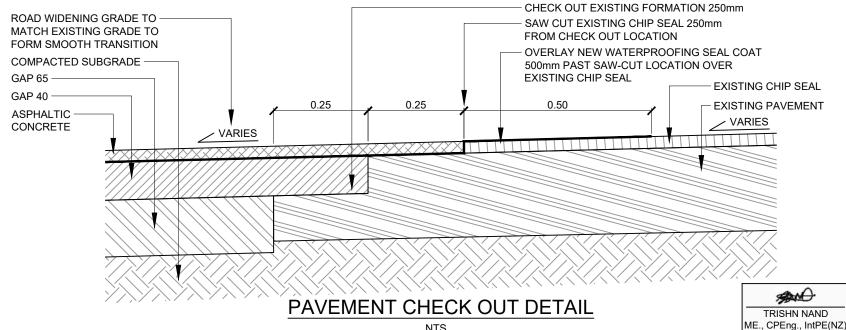



HKRS HOLDINGS LTD
DEVELOPMENT OF
BREAM BAY BUSINESS HUB - STAGE 1A & 1
DETAIL DESIGN ENGINEERING PLANS

COMBINED SERVICE TRENCH & PAVEMENT CHECK OUT DETAILS

DATE CREATED 31-08-2022 AP AP AP TN

VECTA REF NO P0318 AS SHOWN @ A3 FOR APPROVAL

DWG NUMBER DD326 DESIGNED APPROVAL

REVISION D

NOTES:


1. SEE CONSTRUCTION NOTES DD001.

**Approved Plans -**

Whangarei District

Council RCA –SD2200045


JF 19/12/2022

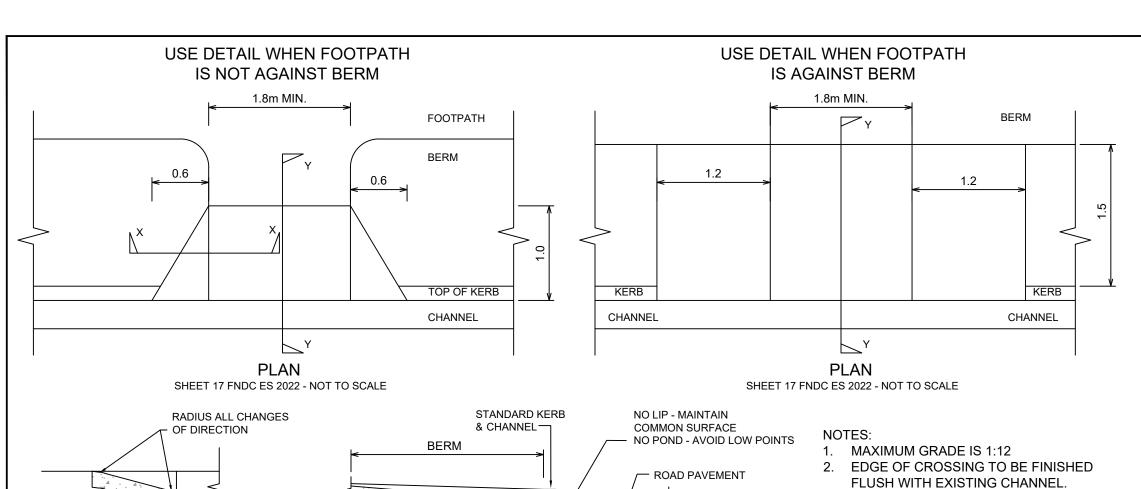

CROSSING SHALL BE CONSTRUCTED IN ACCORDANCE WITH THE REQUIREMENTS FOR A CONCRETE FOOTPATH UNLESS OTHERWISE APPROVED - SEE SHEET 12 FNDC ES 2022.

NOTES:

1. SEE CONSTRUCTION NOTES DD001.

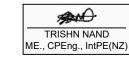

**Approved Plans -**Whangarei District Council RCA -SD2200045

JF 19/12/2022

Dept.	NTA
Approved by:	NM
Date:	14/12/22




**SECTION Y-Y** 

SHEET 17 FNDC ES 2022 - NOT TO SCALE

PRAM CROSSING CHANNEL


(REFER TO SHEET 13)

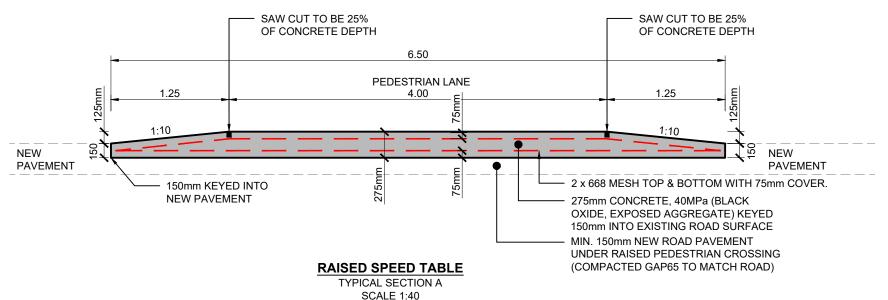

1 IN 12 MAX SLOPE

HALF SECTION X-X

SHEET 17 FNDC ES 2022 - NOT TO SCALE

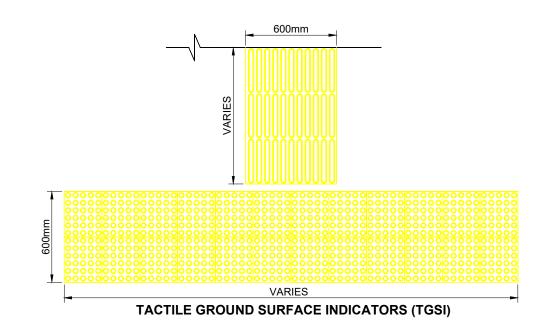




TN

RL-1
Cut / Fill
Design
Posity

Approved Plans Whangarei District
Council RCA –SD2200045
JF 19/12/2022

HORIZ 1:1000 VERT 1:200 LONGITUDINAL SECTION - Road 1

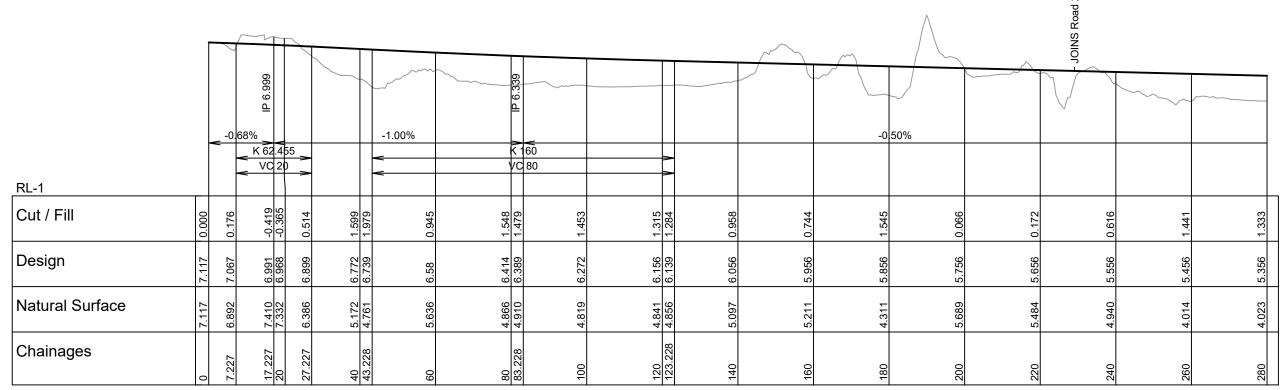

HORIZ 1:1000 VERT 1:200

LONGITUDINAL SECTION - Road 1

NOTES:
1. SEE CONSTRUCTION NOTES DD001.




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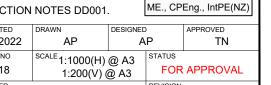
HKRS HOLDINGS LTD
DEVELOPMENT OF
BREAM BAY BUSINESS HUB - STAGE 1A & 1
DETAIL DESIGN ENGINEERING PLANS

ROAD LONGITUDINAL SECTIONS (SHEET 1)

	DATE CREATED	DRAWN DESIGNED		)	APPROVED
	31-08-2022	AP	Α	P	TN
	VECTA REF NO	SCALE 1:1000(H)	@ <b>∆</b> 3	STATUS	
	P0318	1:200(V) @ A3		FOR	APPROVAL
	DWG NUMBER			REVISION	
DD330			D		

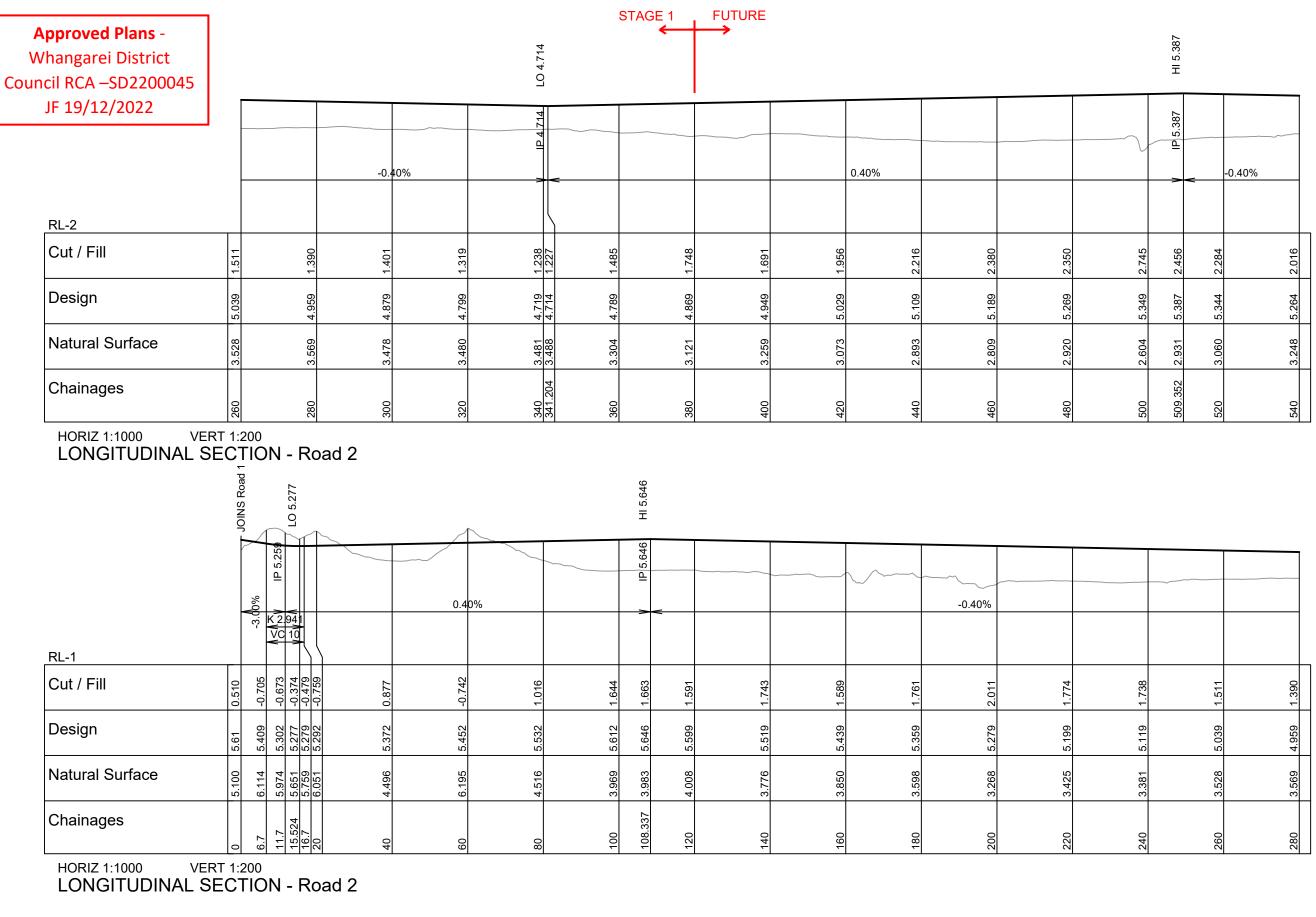

NOTES: 1. SEE CONSTRUCTION NOTES DD001.



AND.

TRISHN NAND

15-12-2022 PROJECT DETAILS FOR APPROVAL - RESPONSE TO RFI'S 2 AP TN 06-12-2022 FOR APPROVAL - RESPONSE TO RFI'S 1 AP TN 04-11-2022 FOR APPROVAL REVISION DETAILS DRAWN APP.

HKRS HOLDINGS LTD DEVELOPMENT OF BREAM BAY BUSINESS HUB - STAGE 1A & 1 DETAIL DESIGN ENGINEERING PLANS

**ROAD LONGITUDINAL SECTIONS** (SHEET 2)

DATE CREATED 31-08-2022 VECTA REF NO P0318 **DD331** DO NOT REPRODUCE WITHOUT WRITTEN AUTHORITY

IP 4.98 0.40% 1.80% K 7.143 VC 10 RL-1 RL-1 Cut / Fill Cut / Fill Design Design 5.491 10.913 Natural Surface **Natural Surface** 3.697 134.093 Chainages Chainages HORIZ 1:1000 **VERT 1:200** HORIZ 1:1000 **VERT 1:200** LONGITUDINAL SECTION - Road 3 **LONGITUDINAL SECTION - ROW 1** -0.40% RL-2 Cut / Fill Design **Approved Plans -Natural Surface** Whangarei District Council RCA -SD2200045 Chainages JF 19/12/2022 640 HORIZ 1:1000 VERT 1:200 LONGITUDINAL SECTION - Road 2 MANO. NOTES: TRISHN NAND ME., CPEng., IntPE(NZ) 1. SEE CONSTRUCTION NOTES DD001.

AP TN 31-08-2022 HKRS HOLDINGS LTD DEVELOPMENT OF 06-12-2022 **ROAD LONGITUDINAL SECTIONS** VECTA REF NO SCALE 1:1000(H) @ A3 FOR APPROVAL - RESPONSE TO RFI'S 1 AP TN FOR APPROVAL P0318 1:200(V) @ A3 BREAM BAY BUSINESS HUB - STAGE 1A & 1 (SHEET 3) 04-11-2022 FOR APPROVAL DETAIL DESIGN ENGINEERING PLANS **DD332** REVISION DETAILS DRAWN APP.

15-12-2022 PROJECT DETAILS

FOR APPROVAL - RESPONSE TO RFI'S 2

151LO 7.451 ₾ ₾ ₾ -0.43% -0.60% RL2 Cut / Fill Design Natural Surface Chainages 40.879


**Approved Plans -**Whangarei District Council RCA -SD2200045

JF 19/12/2022

HORIZ 1:1000 VERT 1:200 LONGITUDINAL SECTION - MPR (MARSDEN POINT ROAD EXISTING CENTRELINE)

FOR APPROVAL

1. SEE CONSTRUCTION NOTES DD001.

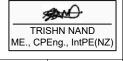


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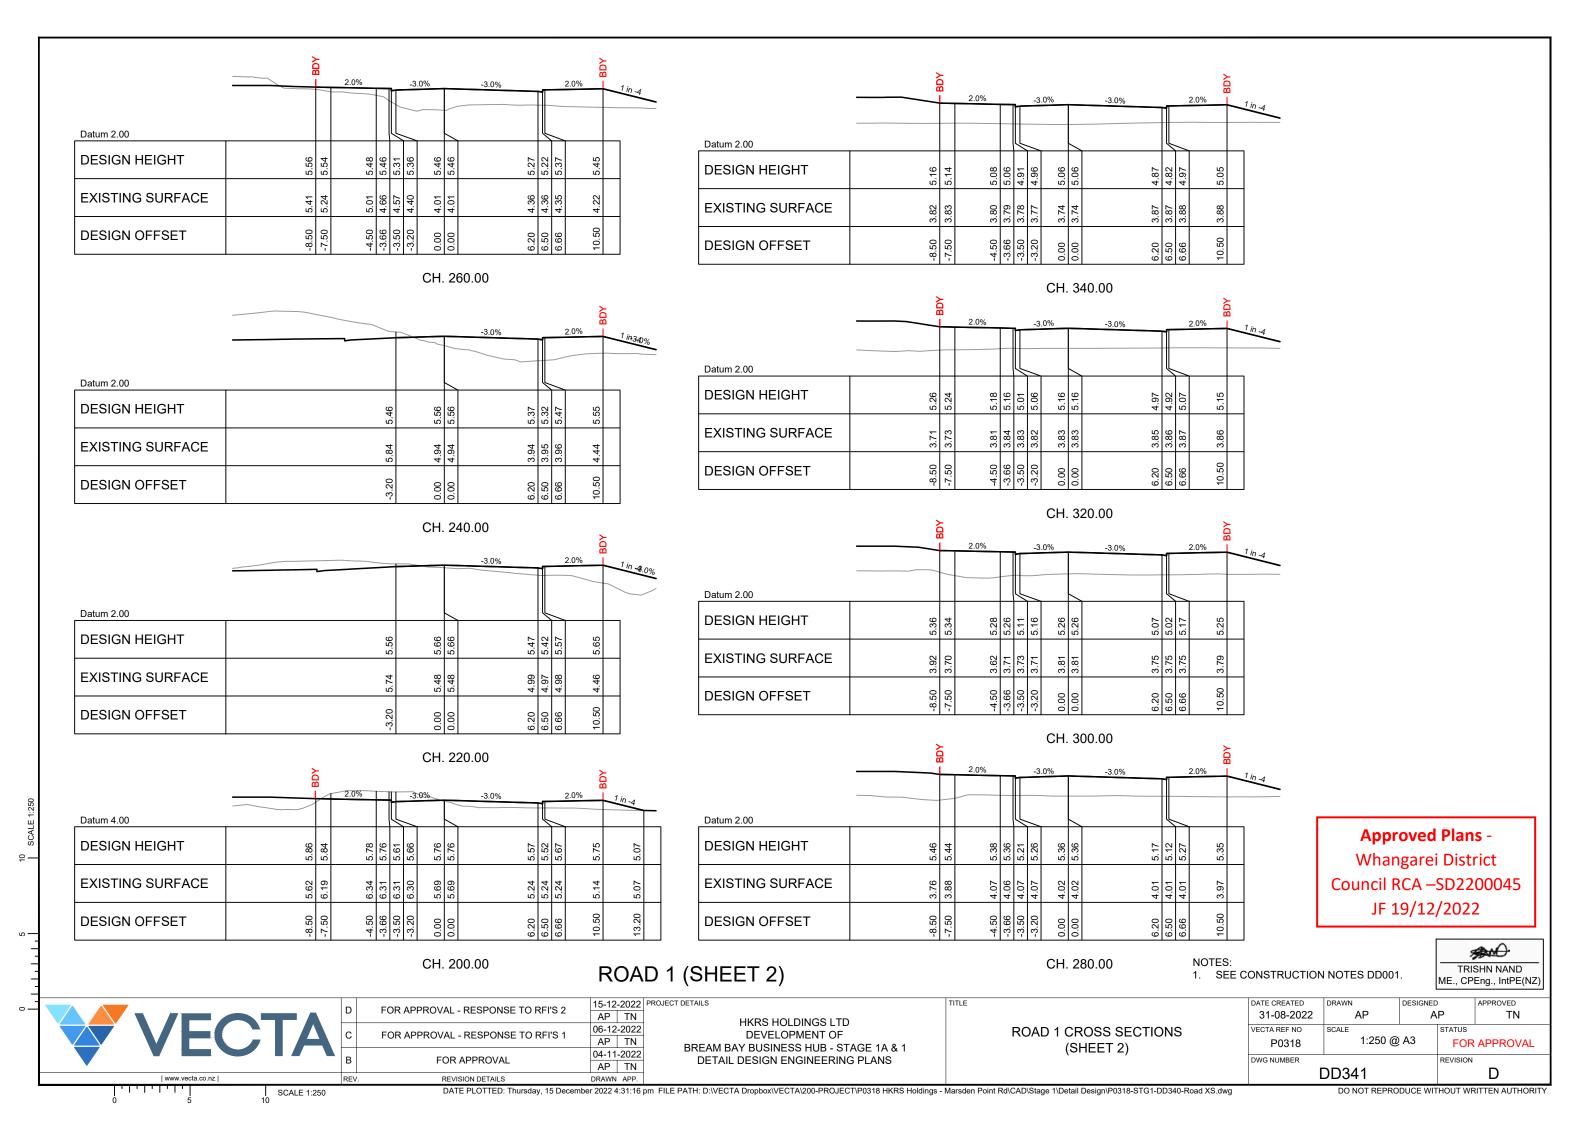
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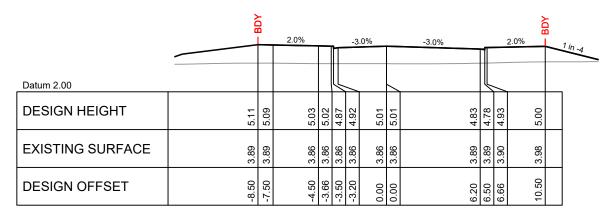
HKRS HOLDINGS LTD DEVELOPMENT OF BREAM BAY BUSINESS HUB - STAGE 1A & 1 DETAIL DESIGN ENGINEERING PLANS


**ROAD LONGITUDINAL SECTIONS** (SHEET 4)

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	VECTA REF NO	<sup>SCALE</sup> 1:1000(H)	@ A3	STATUS	
	P0318	P0318 1:200(V) @ A3		FOR APPROVAL	
	DWG NUMBER			REVISION	
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	DO NOT REPRODUCE WITHOUT WRITTEN AUTHORITY				





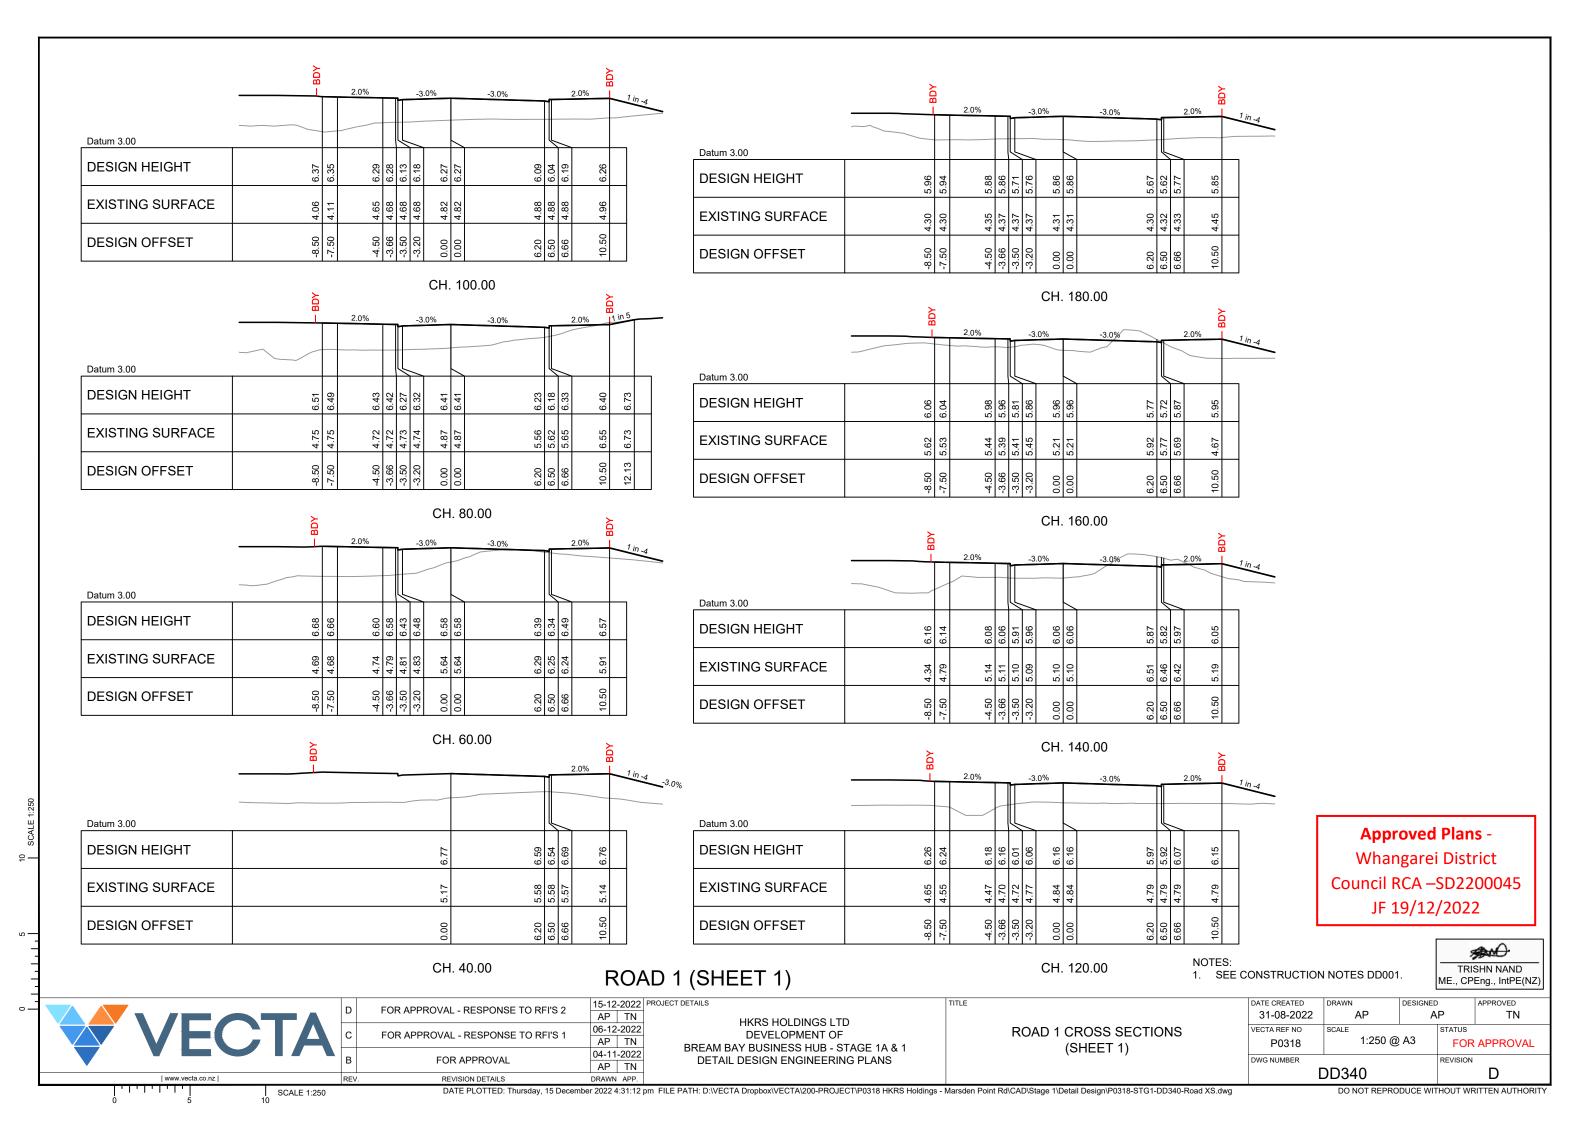

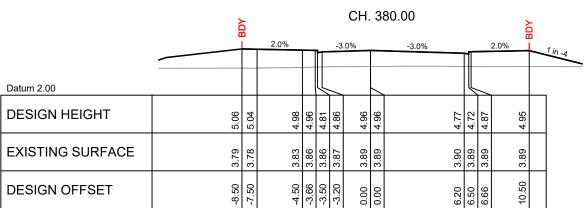

CH. 360.00

ROAD 1 (SHEET 3)

Approved Plans -

Whangarei District
Council RCA –SD2200045
JF 19/12/2022

NOTES:
1. SEE CONSTRUCTION NOTES DD001.



VECTA

| FOR APPROVAL - RESPONSE TO RFI'S 2 | TS-12-2022 | AP | TN | TN | O6-12-2022 | AP | TN | TN | O6-12-2022 | AP | TN | O6-11-2022 | AP | TN | OF TO REVISION DETAILS | DRAWN | APP.

HKRS HOLDINGS LTD DEVELOPMENT OF BREAM BAY BUSINESS HUB - STAGE 1A & 1 DETAIL DESIGN ENGINEERING PLANS


ROAD 1 CROSS SECTIONS (SHEET 3)


DATE CREATED	DRAWN	DESIGNED	)	APPROVED
31-08-2022	AP	A	.P	TN
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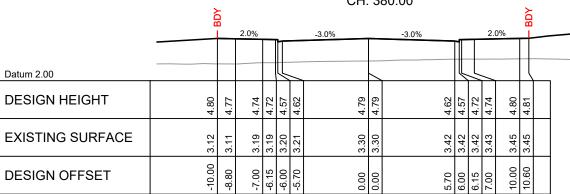
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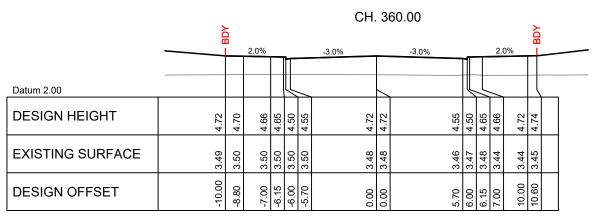
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CH. 340.00

# ROAD 2 (SHEET 3)

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NOTES:
1. SEE CONSTRUCTION NOTES DD001.

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l	ME., CPEng., IntPE(NZ)
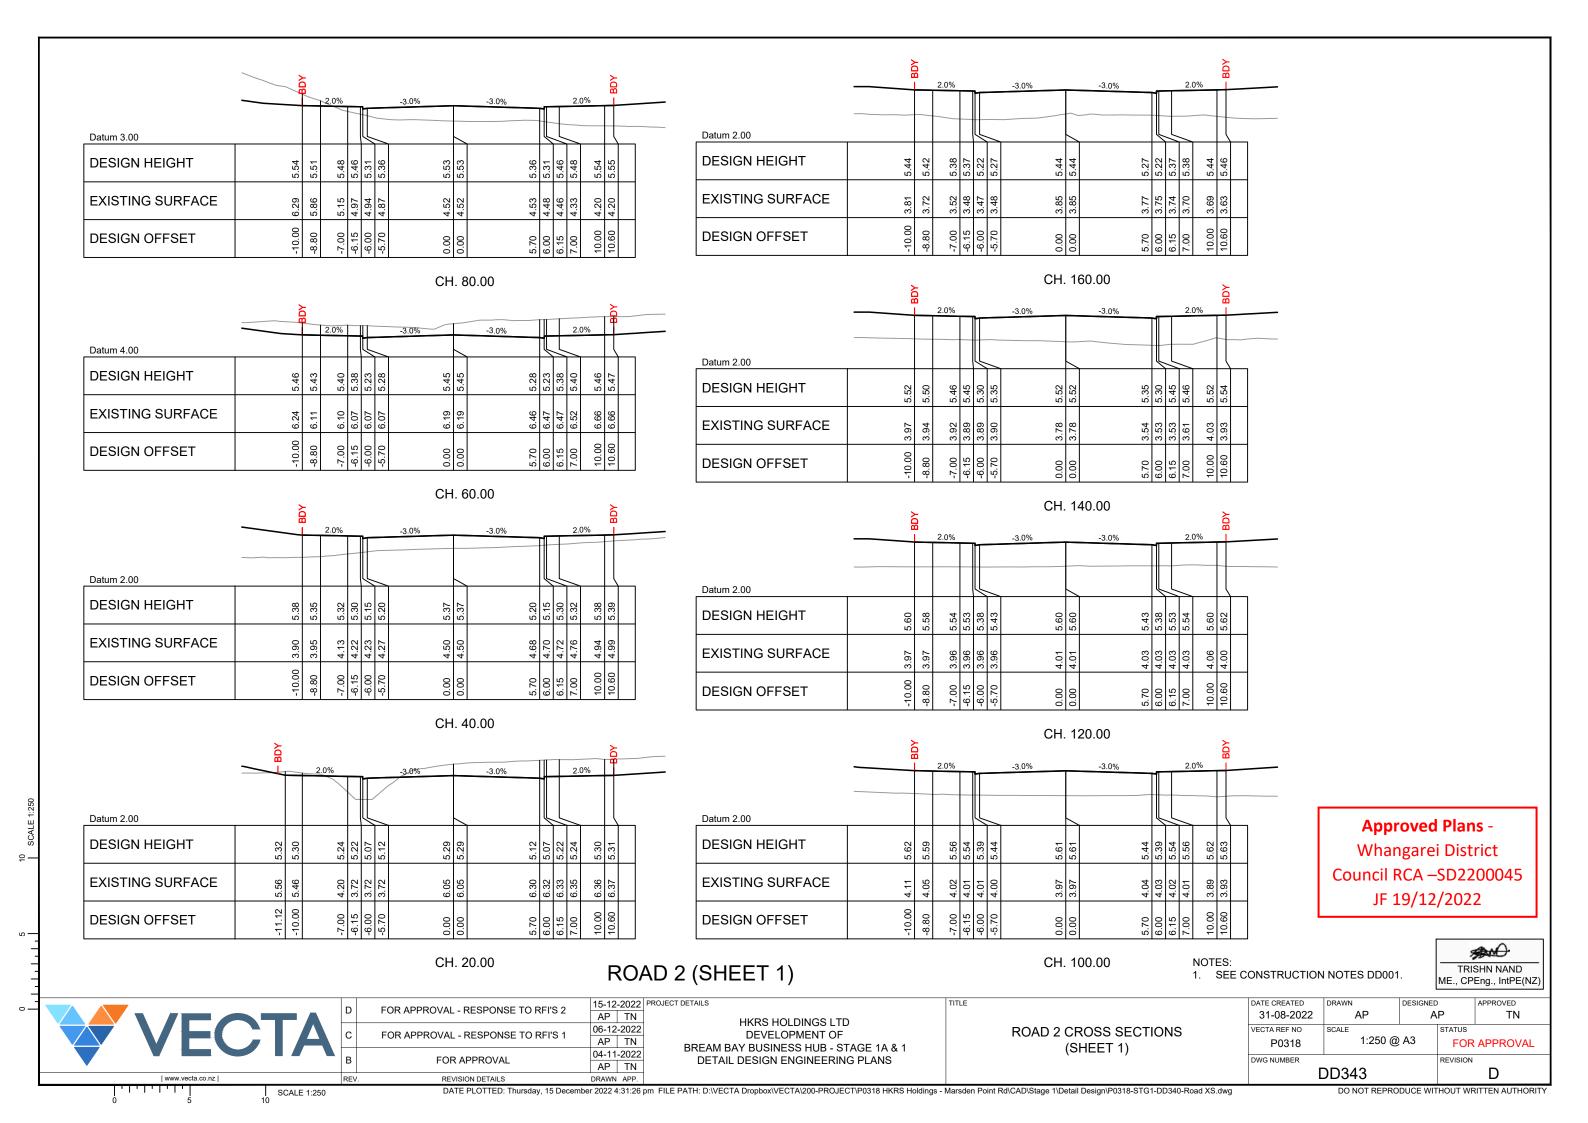
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SCALE 1:250

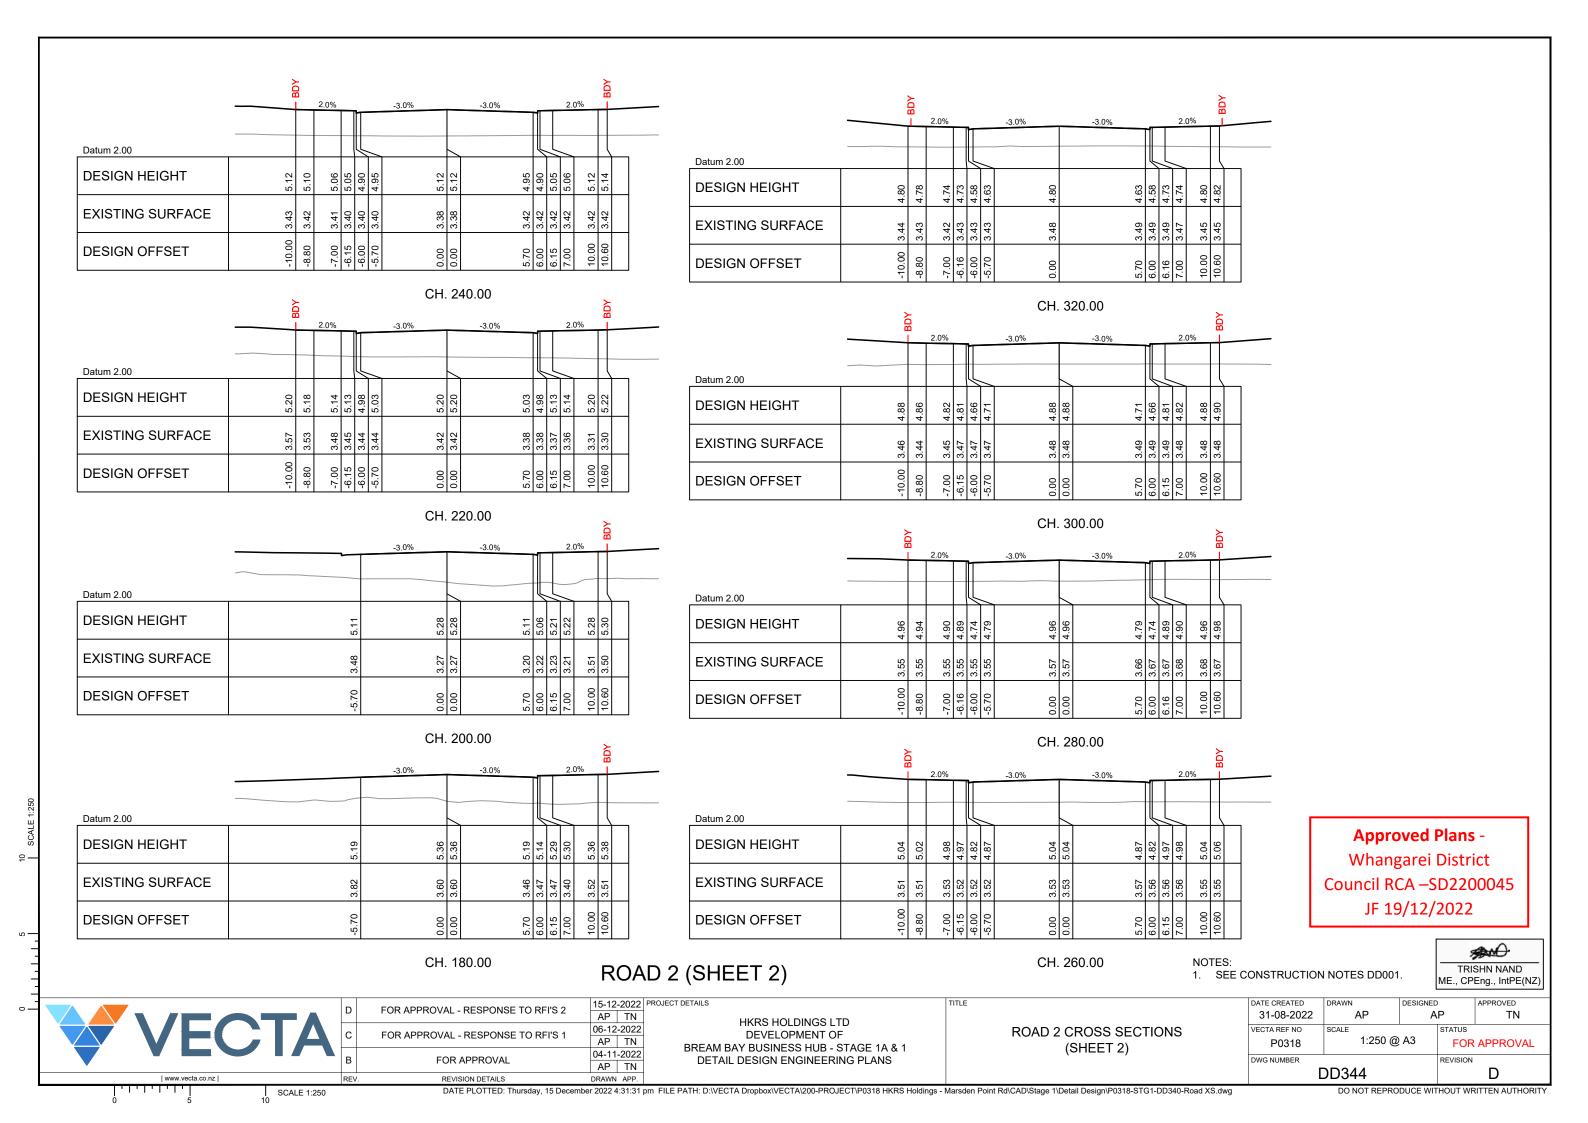
HKRS HOLDINGS LTD
DEVELOPMENT OF
BREAM BAY BUSINESS HUB - STAGE 1A & 1
DETAIL DESIGN ENGINEERING PLANS

ROAD 2 CROSS SECTIONS (SHEET 3)

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31-08-2022	AP	_ A	.P	TN
VECTA REF NO	SCALE		STATUS	
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REVISION DETAILS DRAWN APP.

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Approved Plans -Whangarei District Council RCA –SD2200045 JF 19/12/2022

20.00 ROAD 3 (SHEET 1)

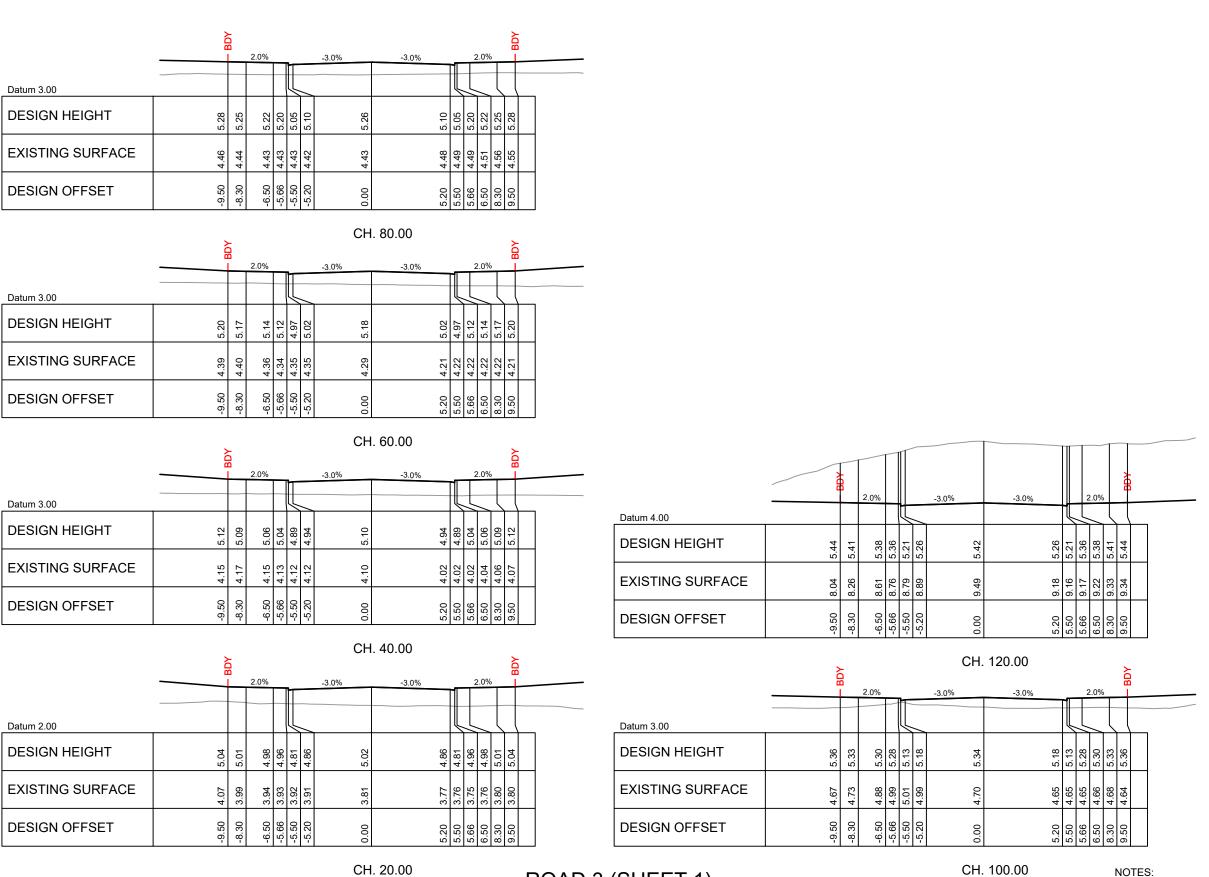NOTES:
1. SEE CONSTRUCTION NOTES DD001.

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SCALE 1:250


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В	FOR APPROVAL	04-11	-2022
	FOR AFFROVAL		TN

HKRS HOLDINGS LTD
DEVELOPMENT OF
BREAM BAY BUSINESS HUB - STAGE 1A & 1
DETAIL DESIGN ENGINEERING PLANS

ROAD 3 CROSS SECTIONS (SHEET 1)

DATE CREATED	DRAWN	DESIGNED	)	APPROVED
31-08-2022	AP	AP		TN
VECTA REF NO	SCALE		STATUS	
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Approved Plans -Whangarei District Council RCA –SD2200045 JF 19/12/2022

ROW 1 (SHEET 1)

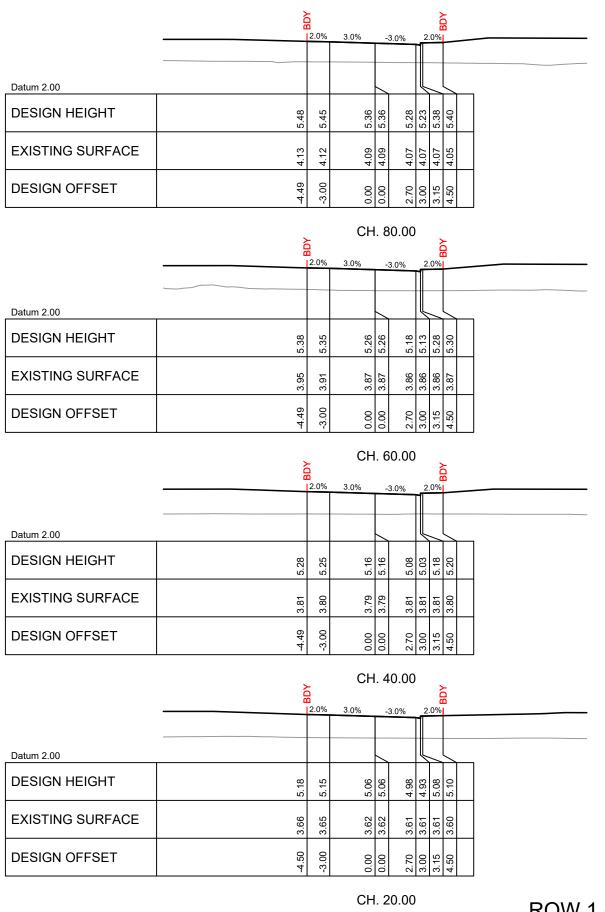NOTES:
1. SEE CONSTRUCTION NOTES DD001.

TRISHN NAND ME., CPEng., IntPE(NZ)

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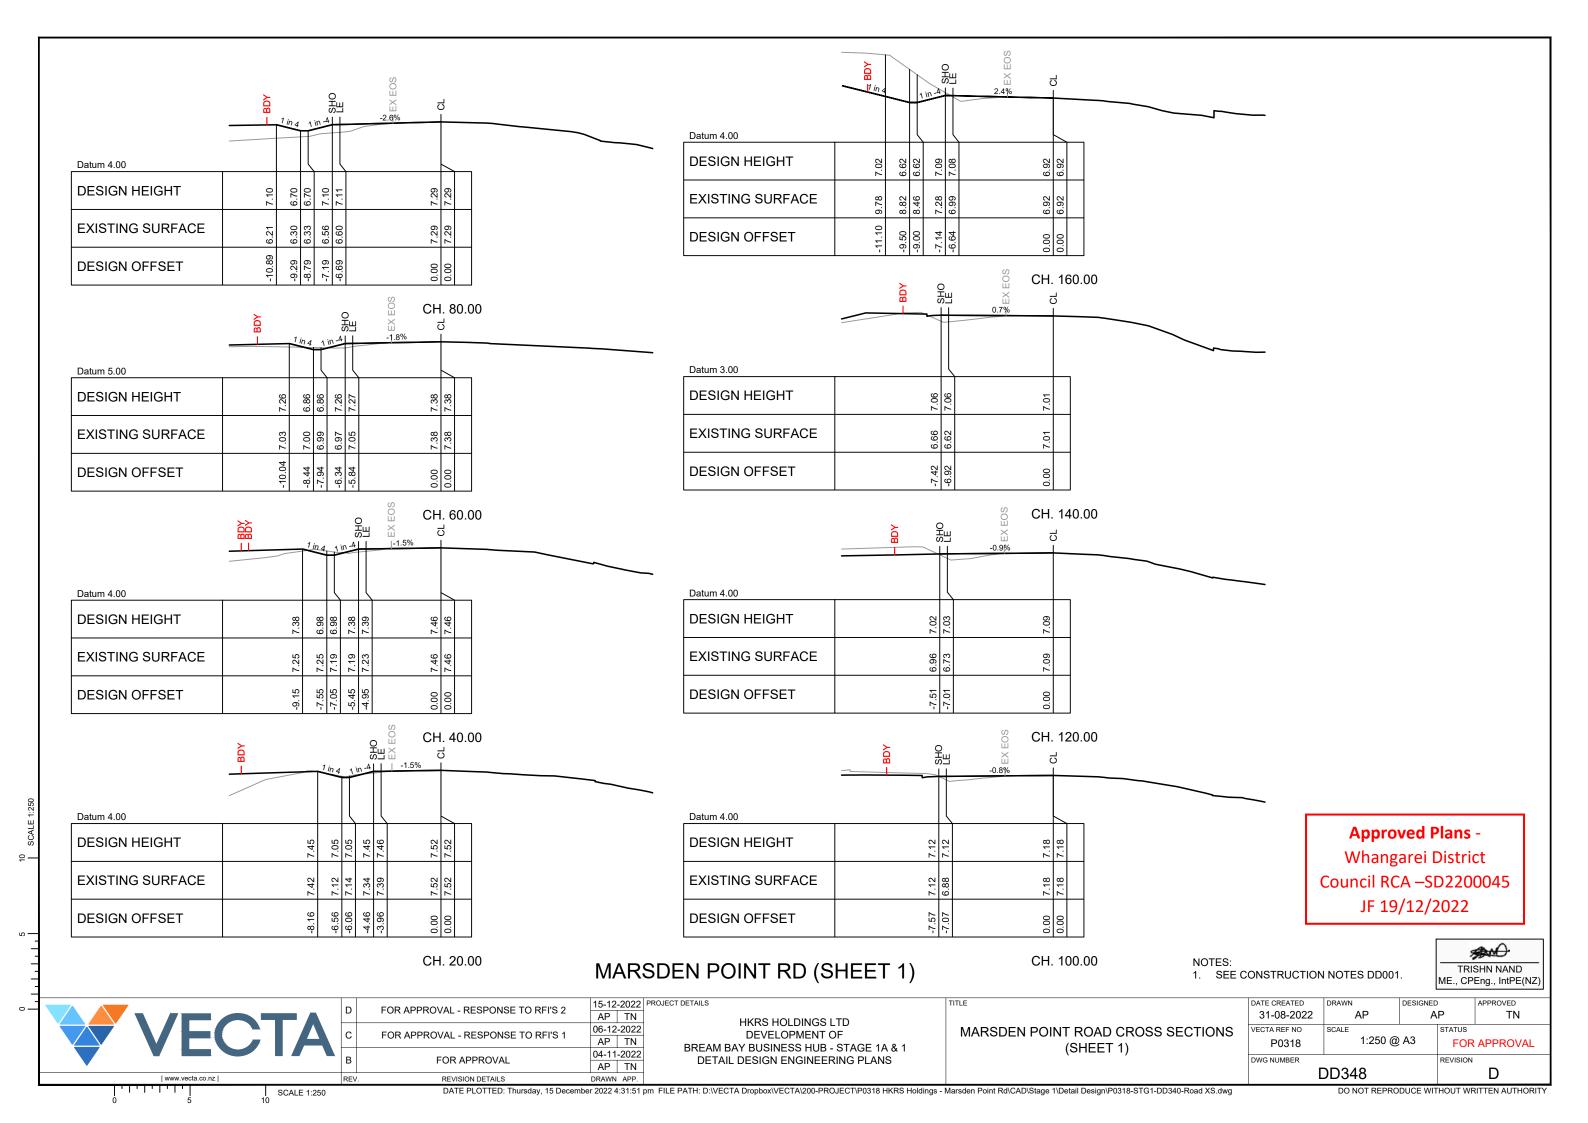
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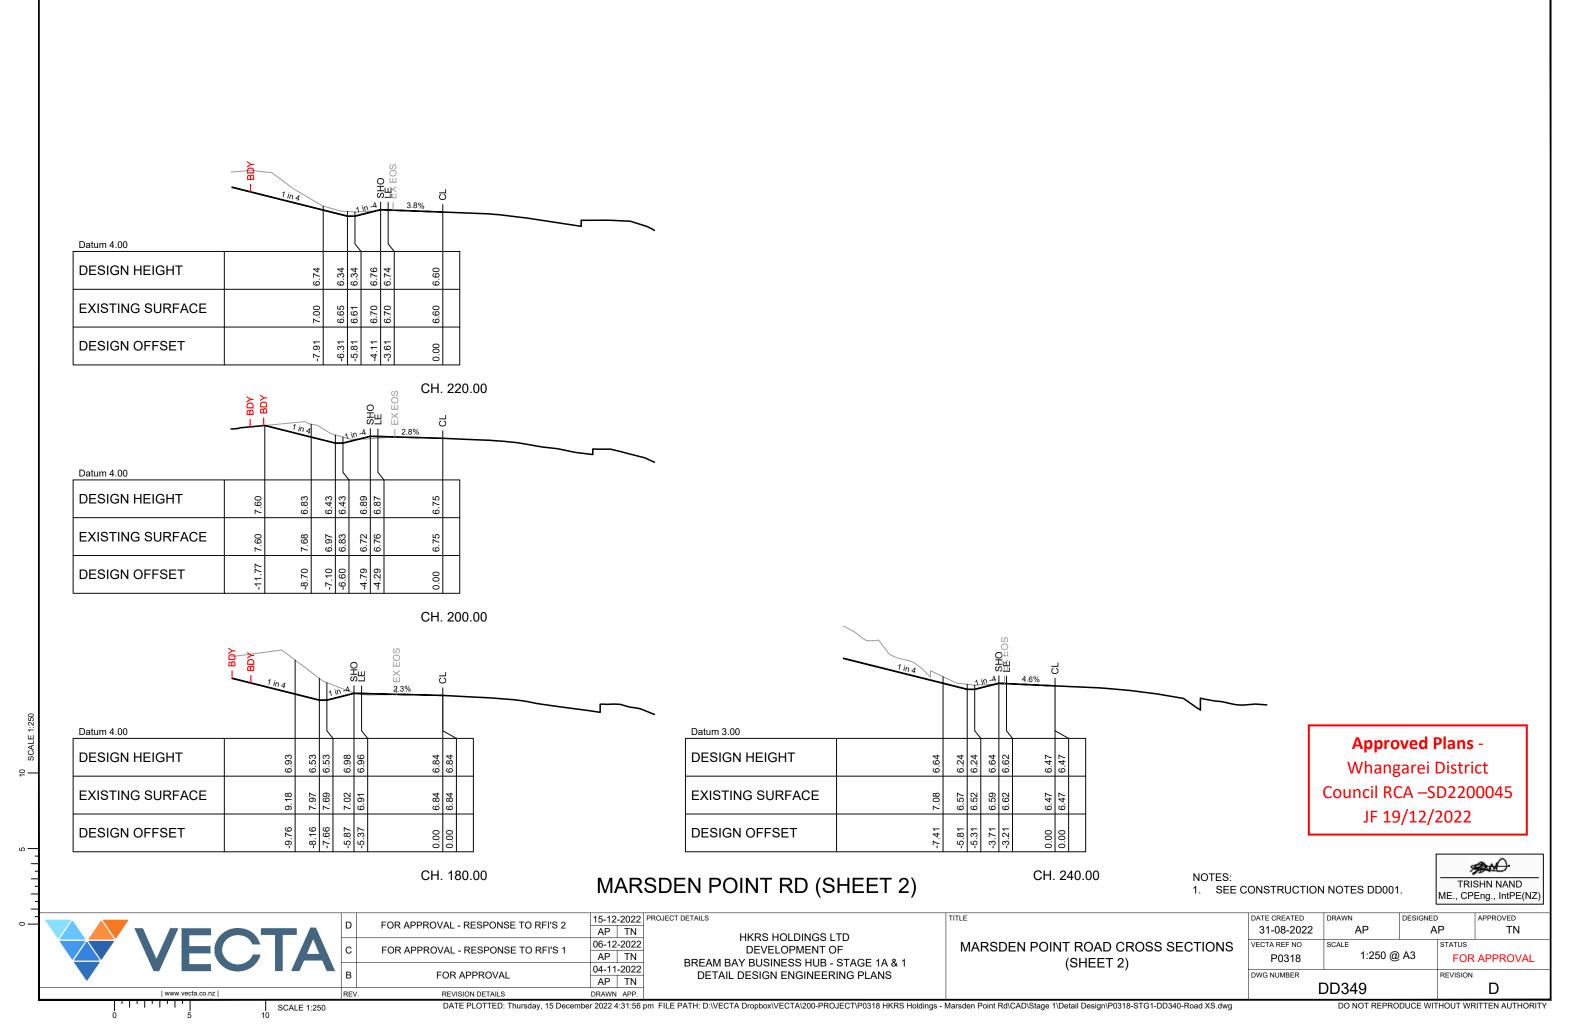
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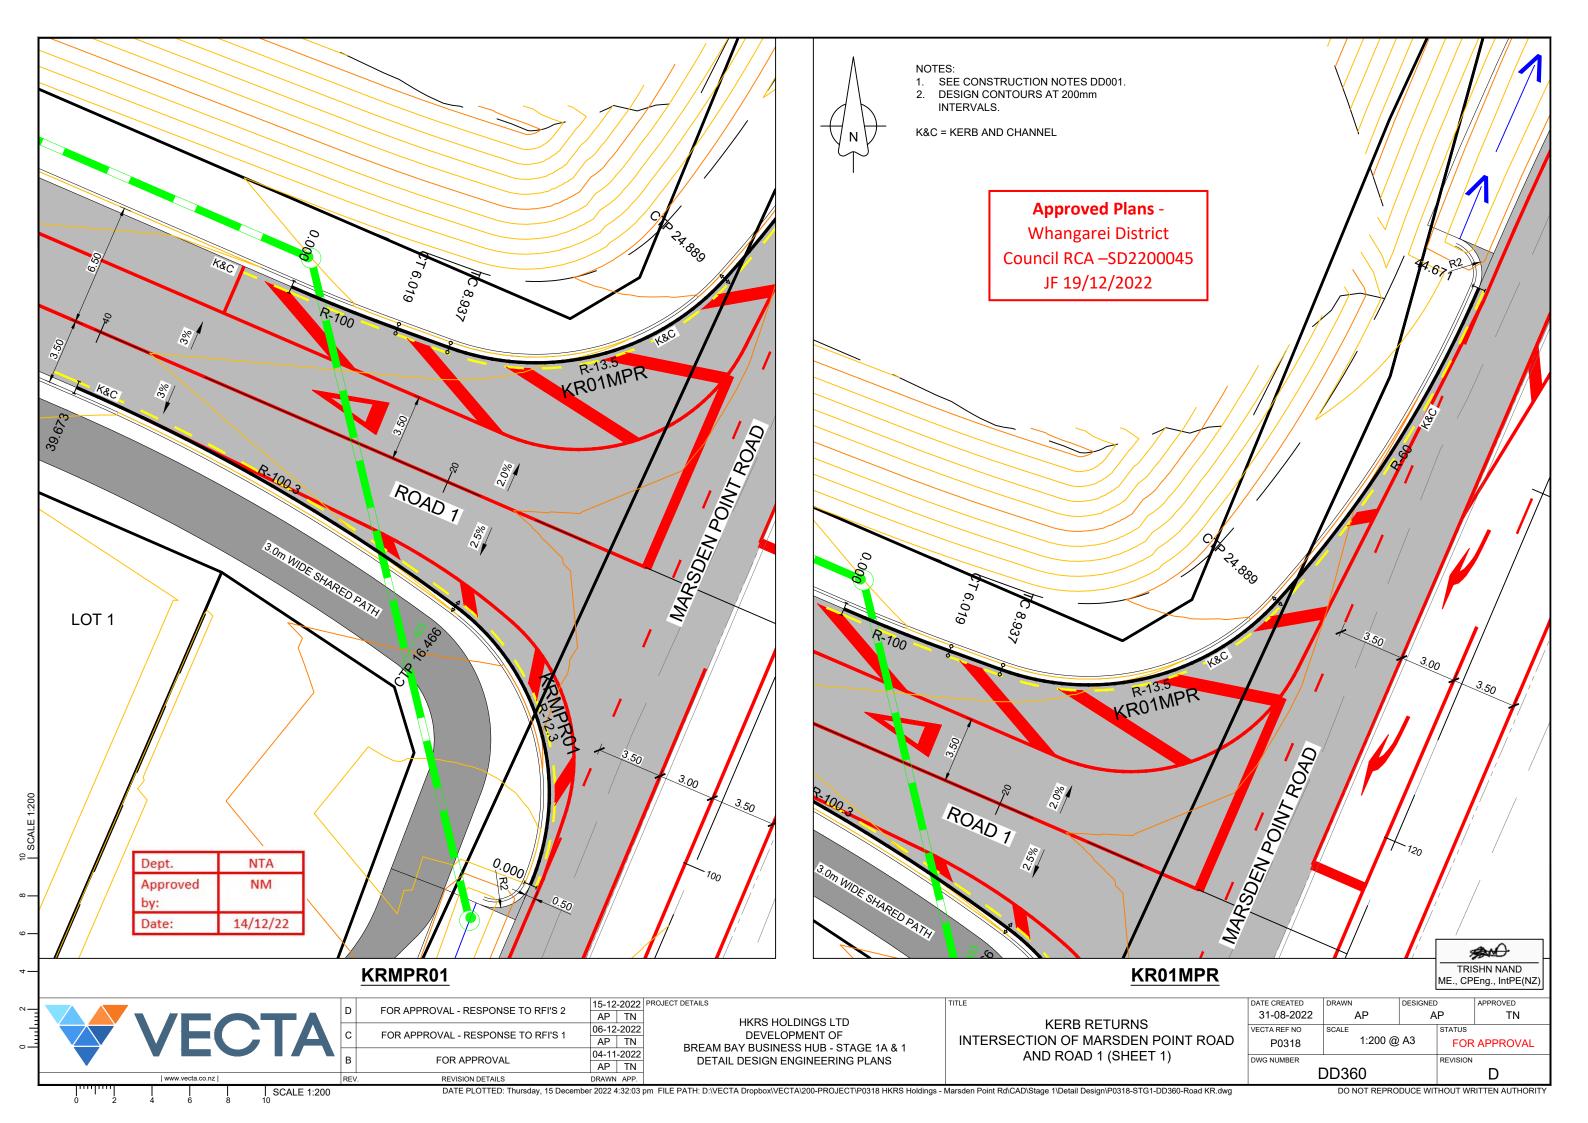
HKRS HOLDINGS LTD
DEVELOPMENT OF
BREAM BAY BUSINESS HUB - STAGE 1A & 1
DETAIL DESIGN ENGINEERING PLANS

ROW 1 CROSS SECTIONS (SHEET 1)

	DATE CREATED	DRAWN	DESIGNED	)	APPROVED	
	31-08-2022	AP	AP		TN	
	VECTA REF NO	SCALE		STATUS		
	P0318	1:250 @	1:250 @ A3		FOR APPROVAL	
	DWG NUMBER			REVISION		
	DD347			D		
DO NOT REPRODUCE WITHOUT WRITTEN AUTHORITY						







- NOTES:

  1. SEE CONSTRUCTION NOTES DD001.
- DESIGN CONTOURS AT 200mm INTERVALS.


K&C = KERB AND CHANNEL

0.93% 0.\$7% VC 4.418 VC 4.418 VC 17.767 VC 17.767 RL5 Design 6.921 Chainages 24.889

Horizontal 1:200 Vertical 1:40

LONGITUDINAL SECTION KR01MPR

HI 7.115

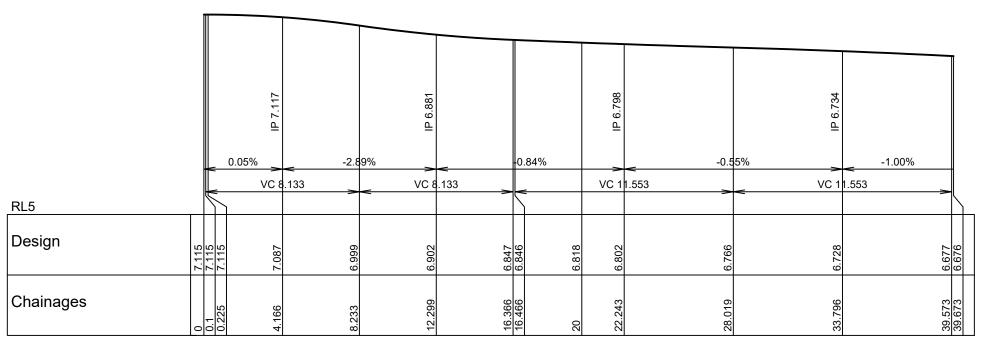

Horizontal 1:200 Vertical 1:40 LONGITUDINAL SECTION KRMPR01 **Approved Plans -**

Whangarei District Council RCA -SD2200045 JF 19/12/2022





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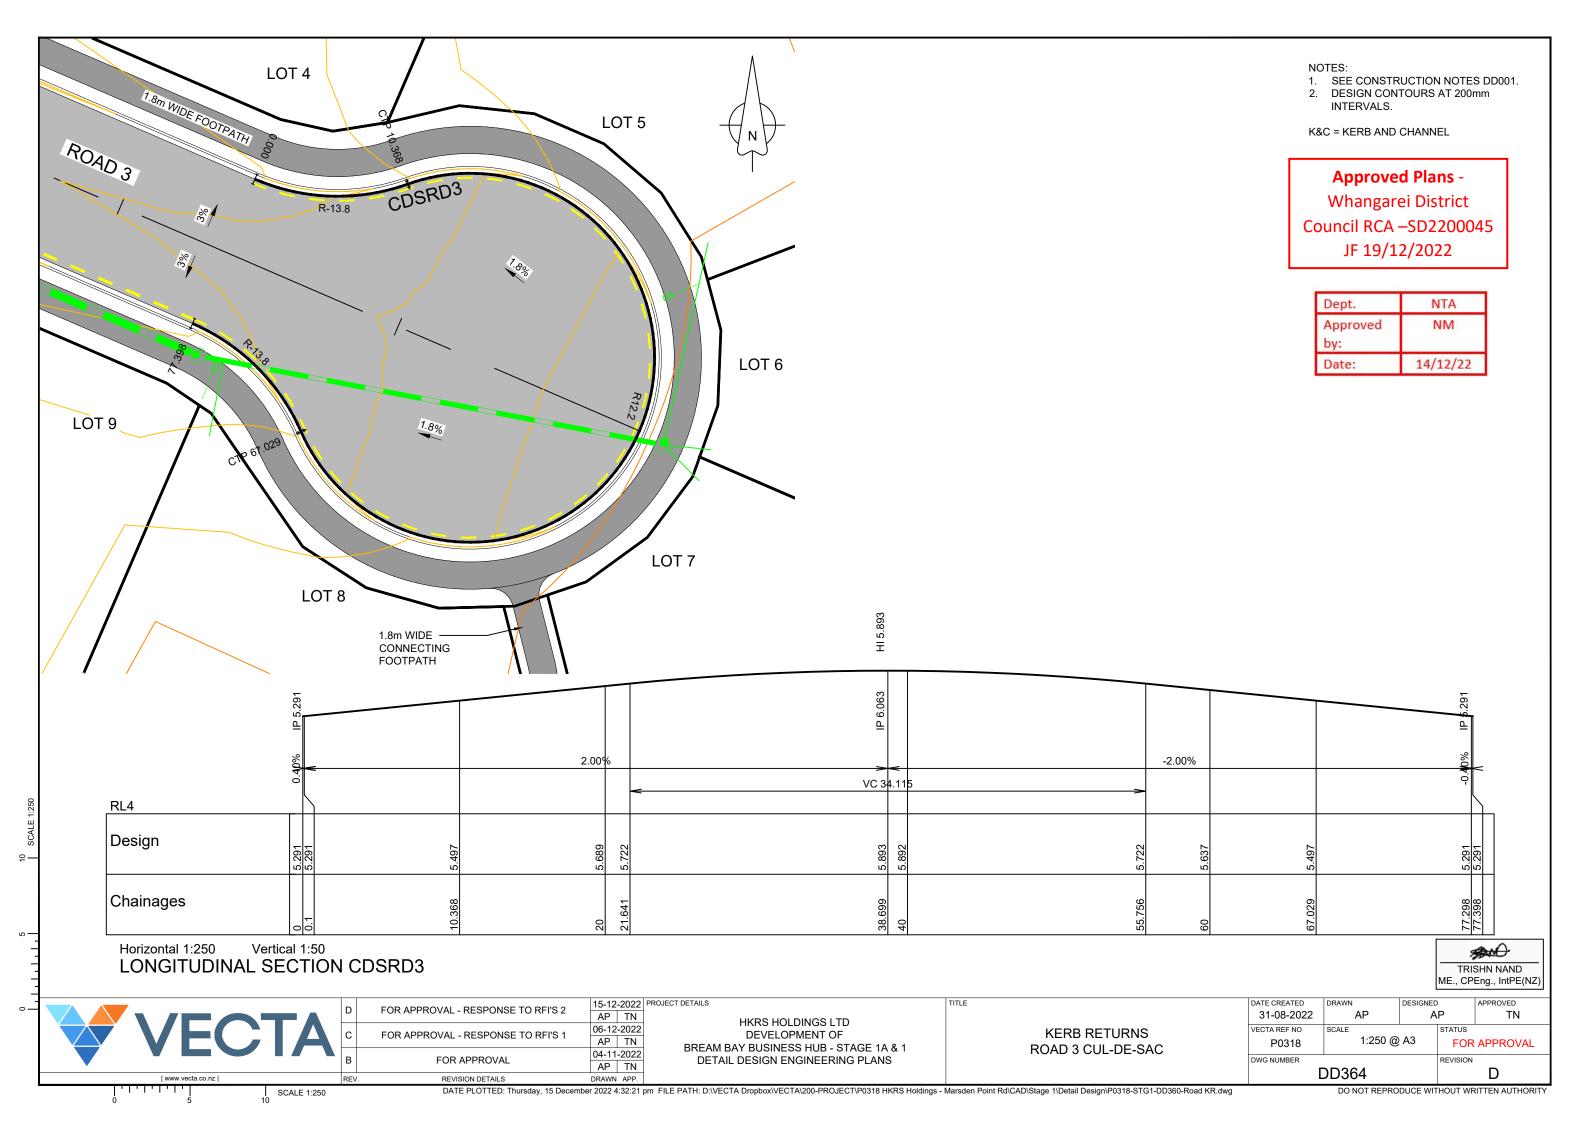
HKRS HOLDINGS LTD DEVELOPMENT OF BREAM BAY BUSINESS HUB - STAGE 1A & 1 DETAIL DESIGN ENGINEERING PLANS


KERB RETURNS INTERSECTION OF MARSDEN POINT ROAD AND ROAD 1 (SHEET 2)


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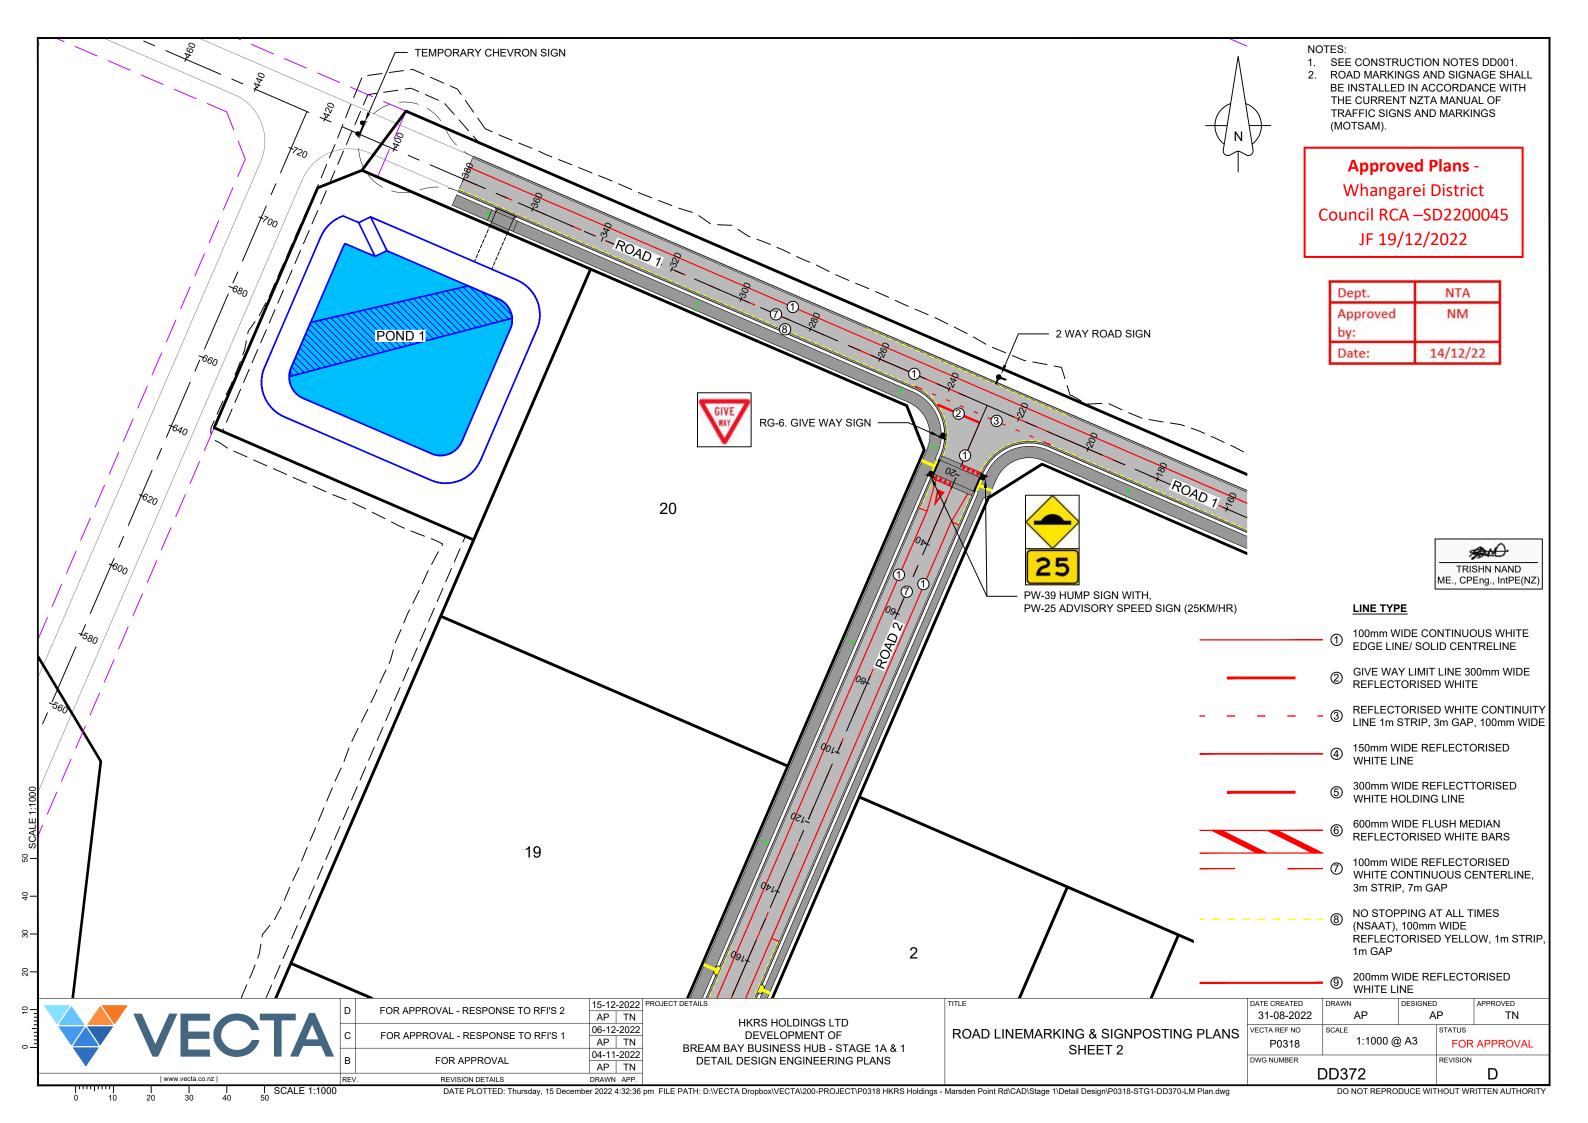





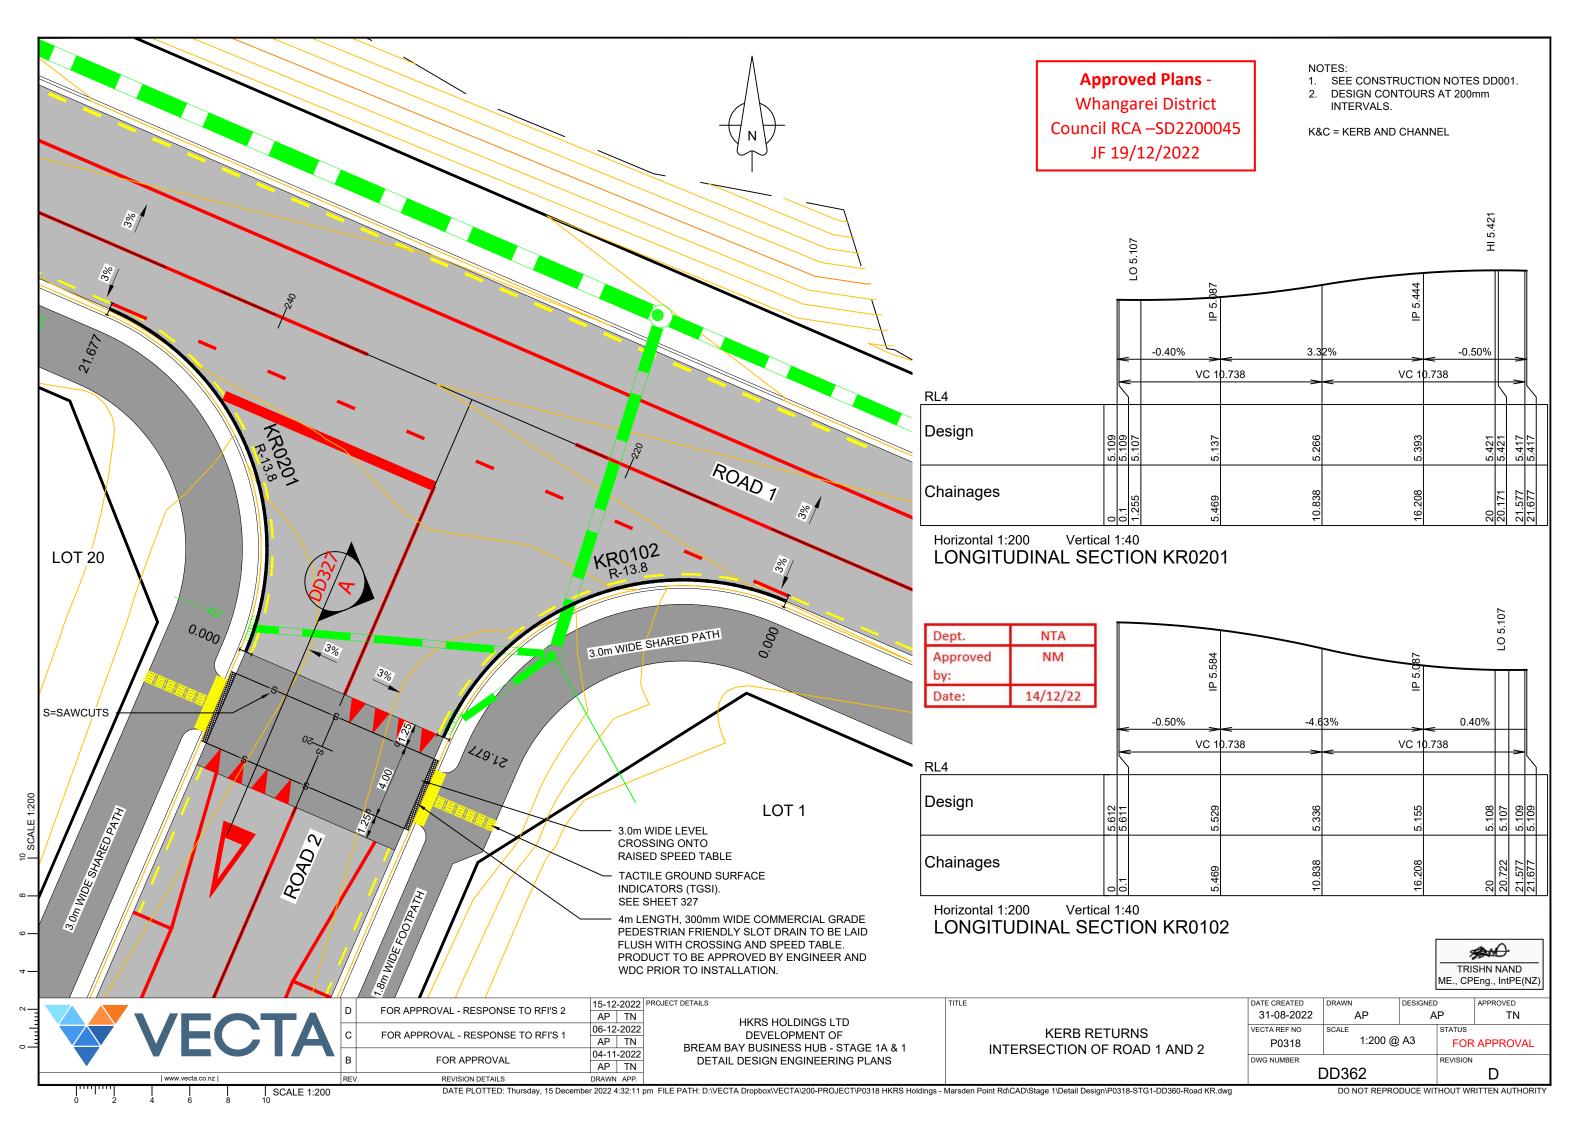


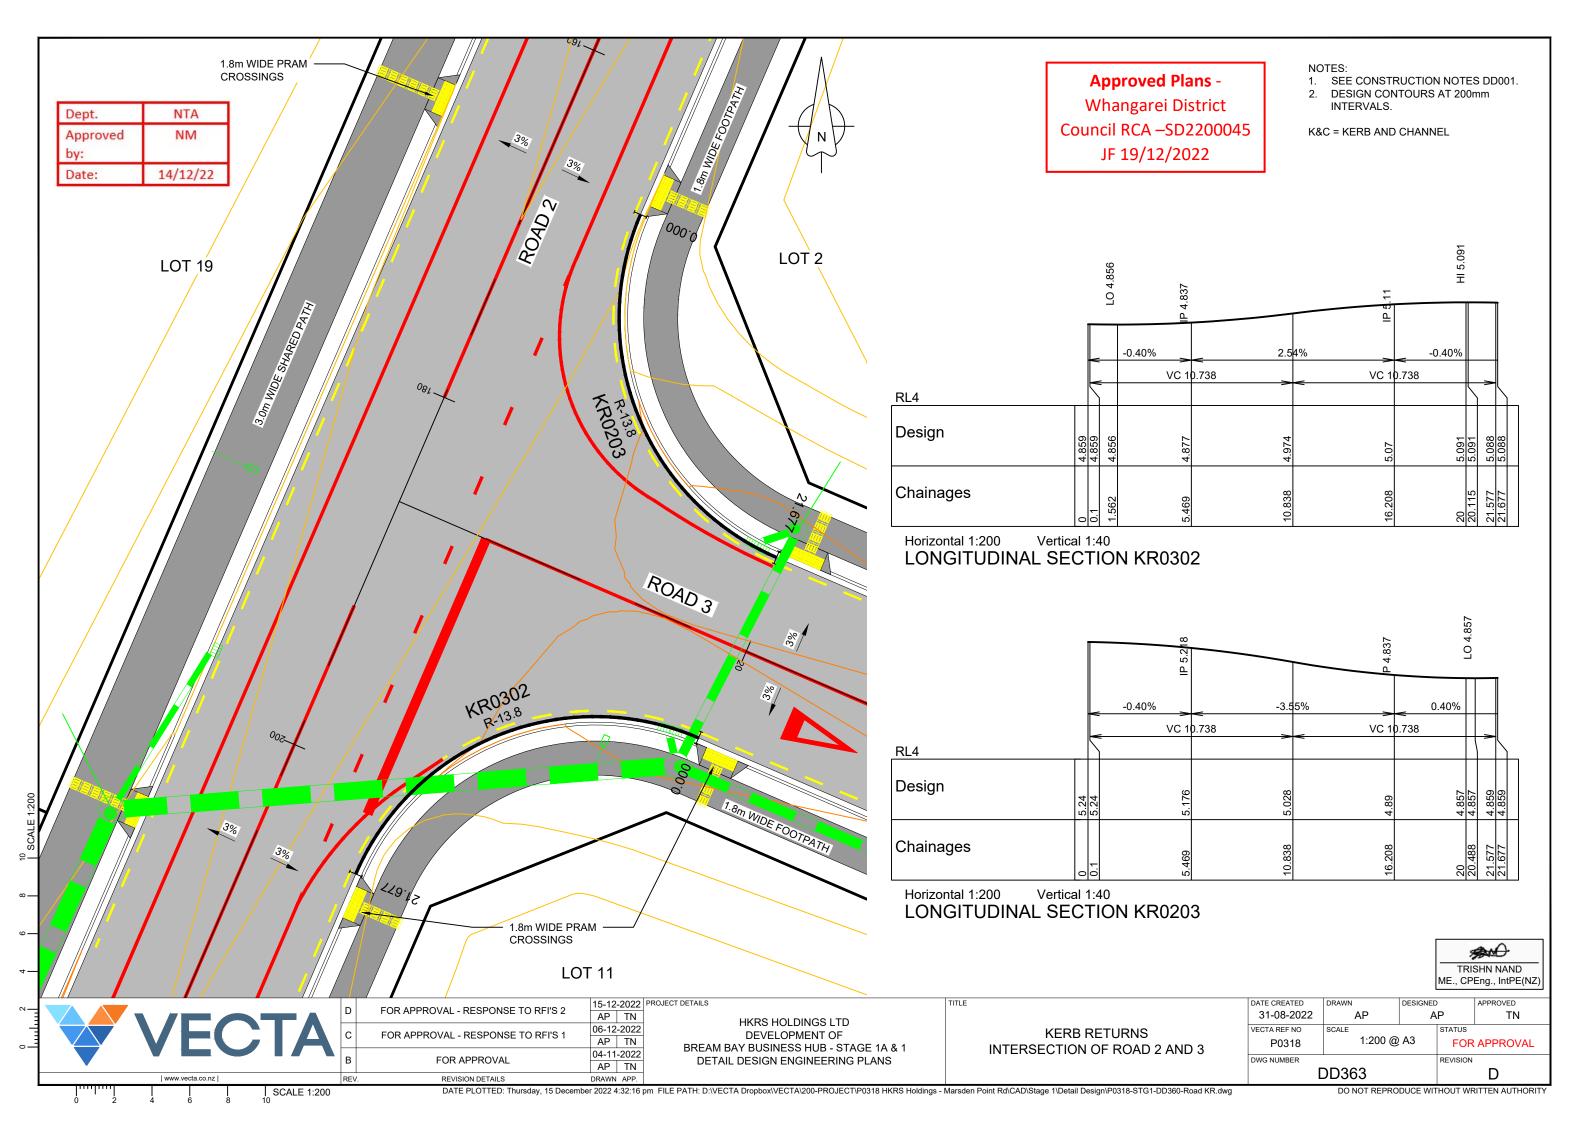


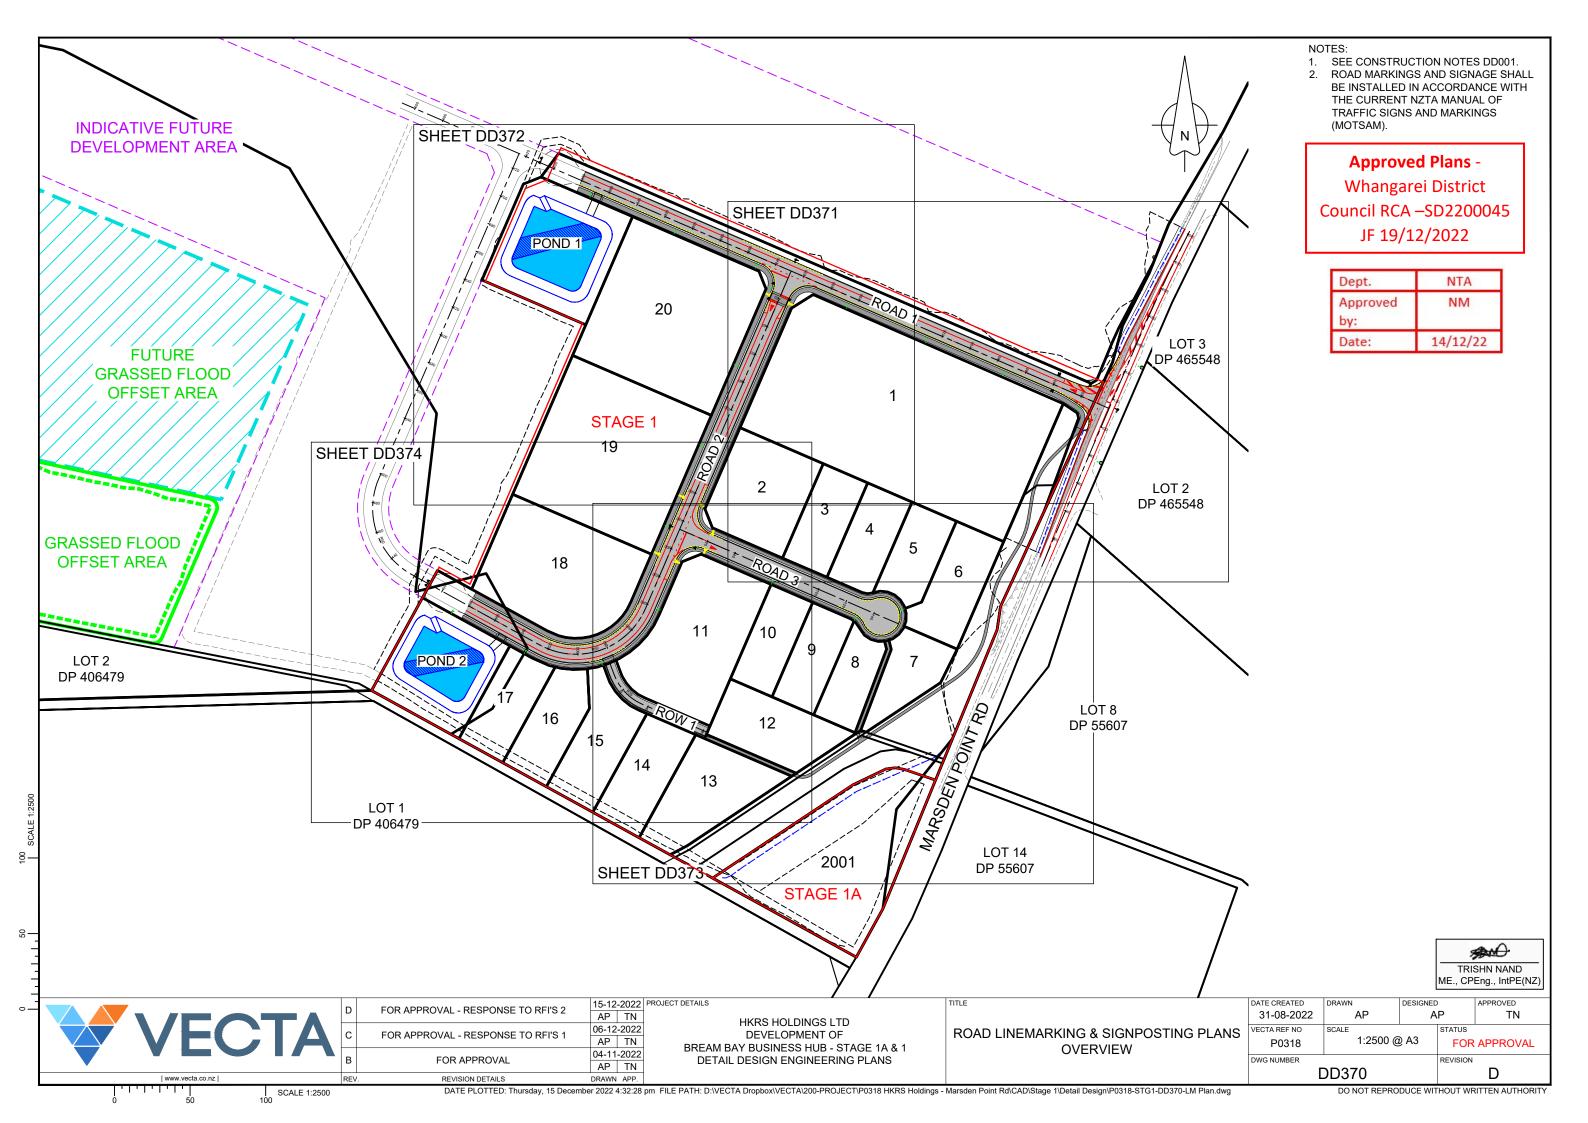

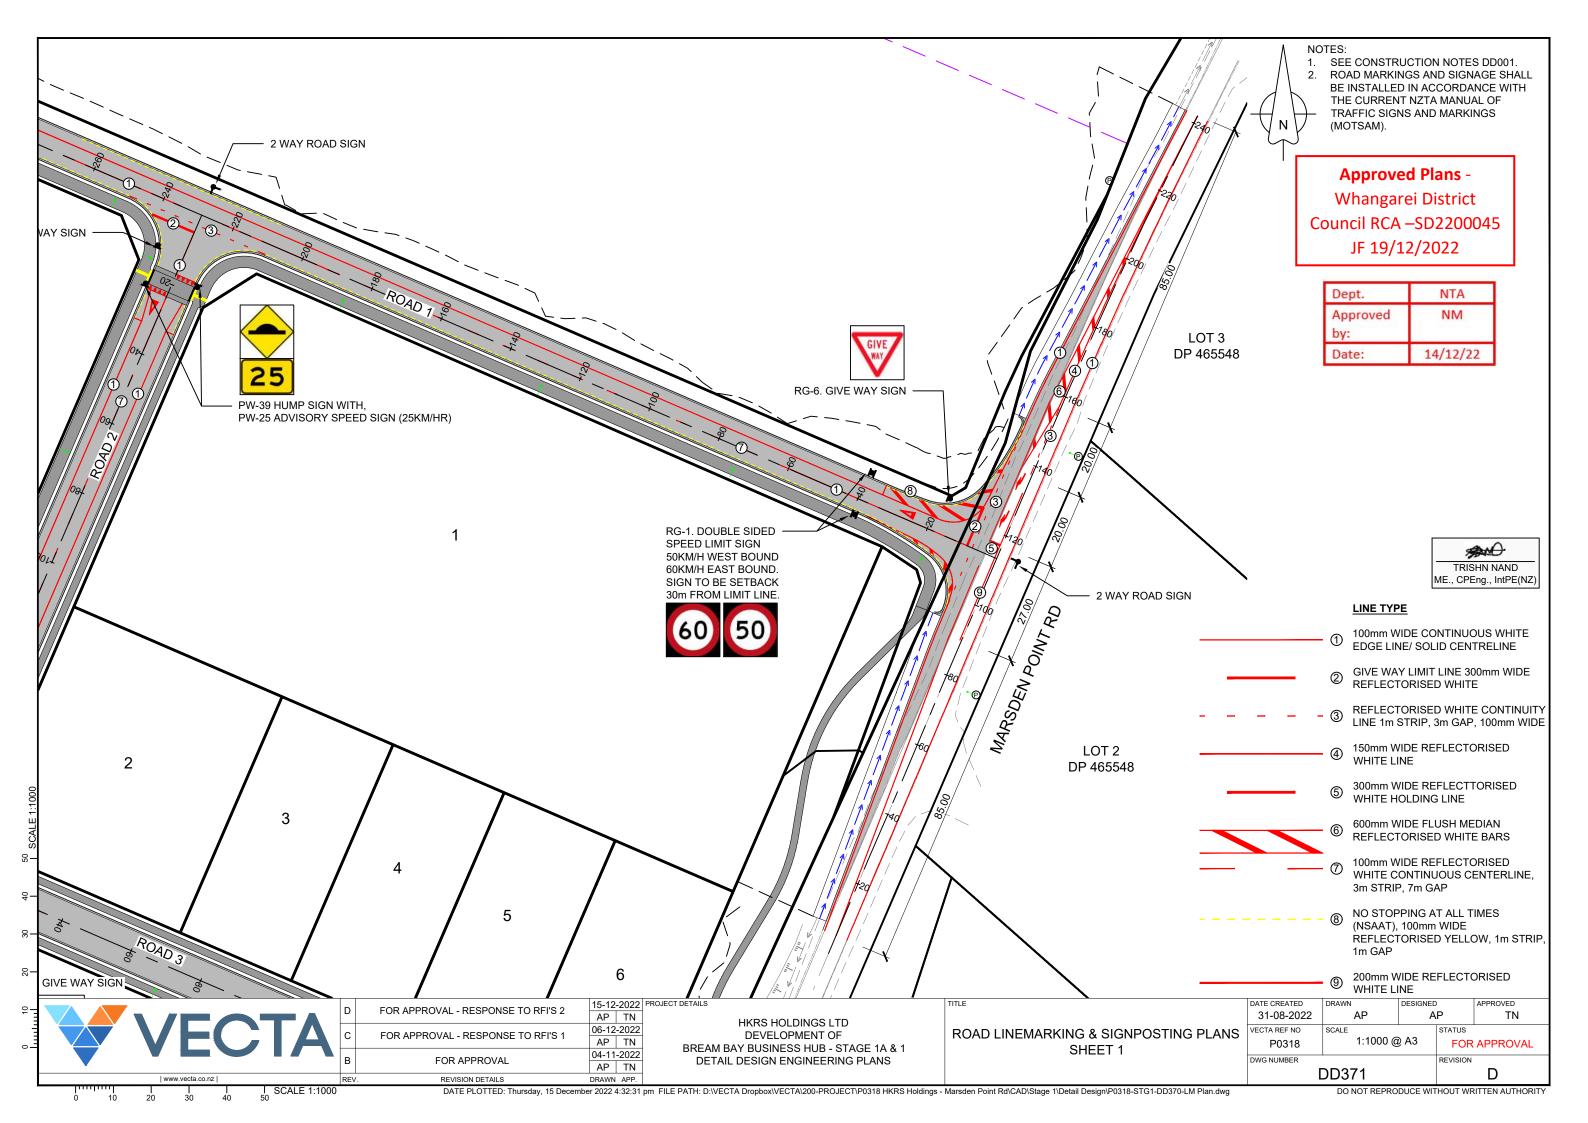

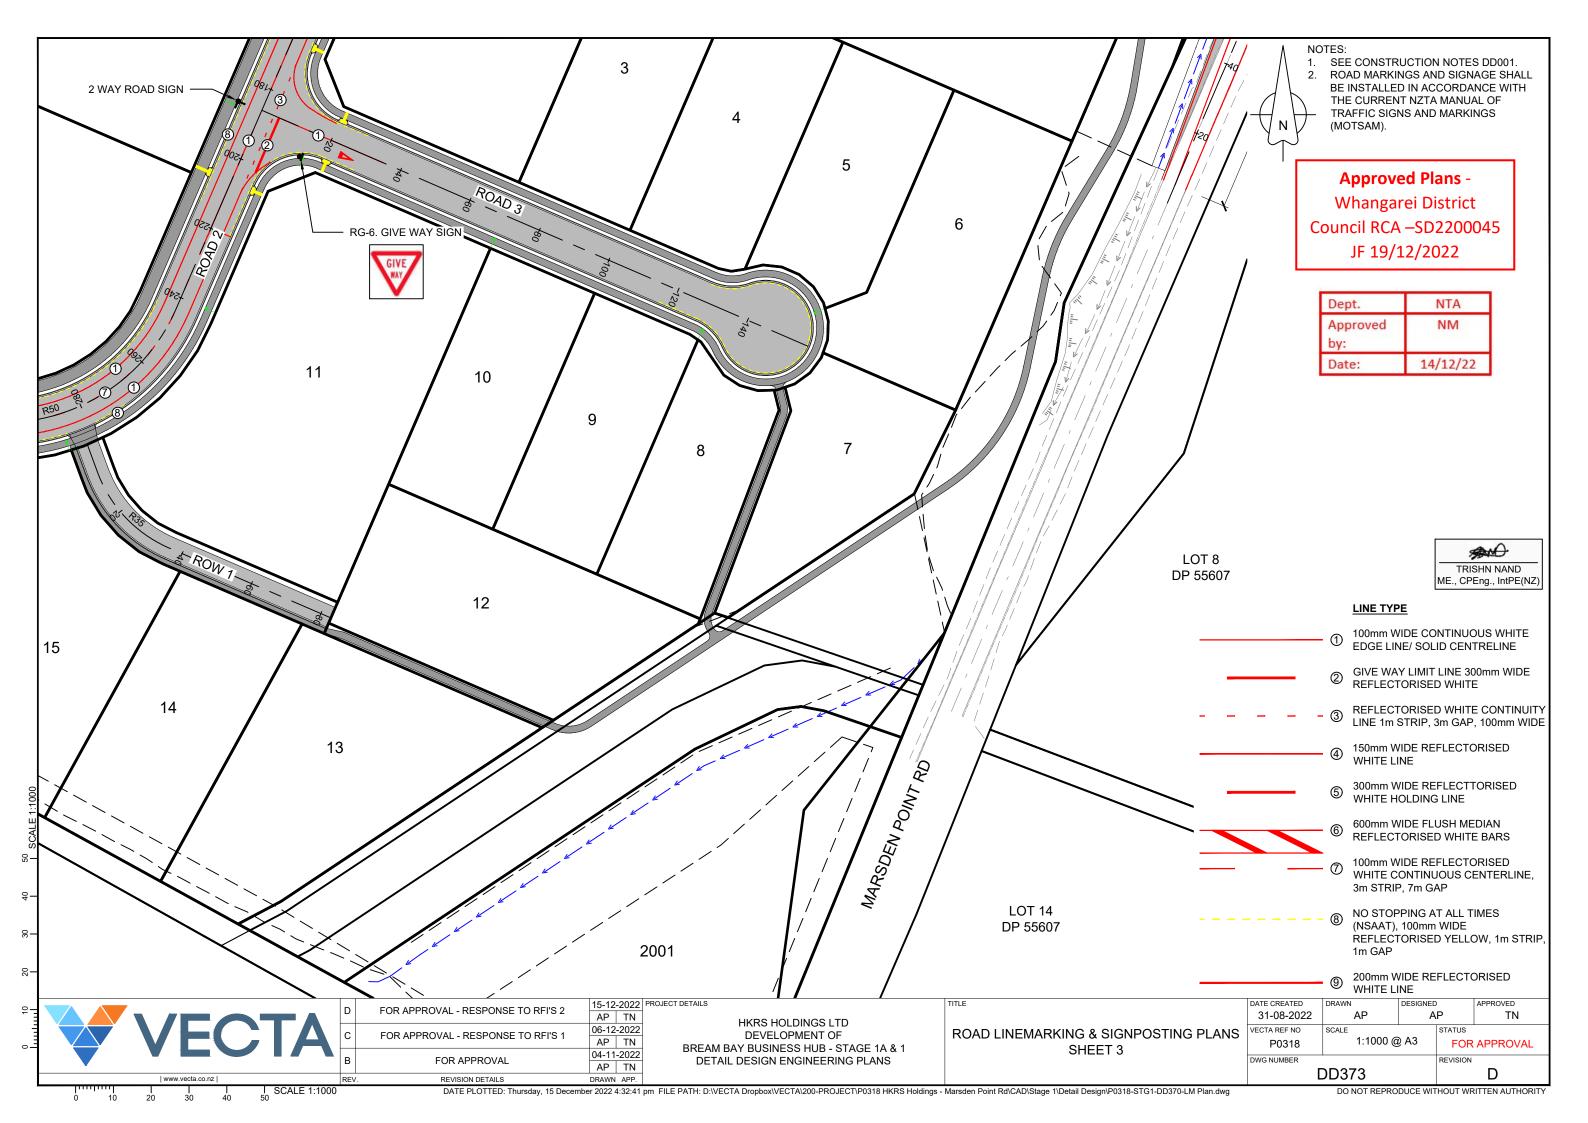

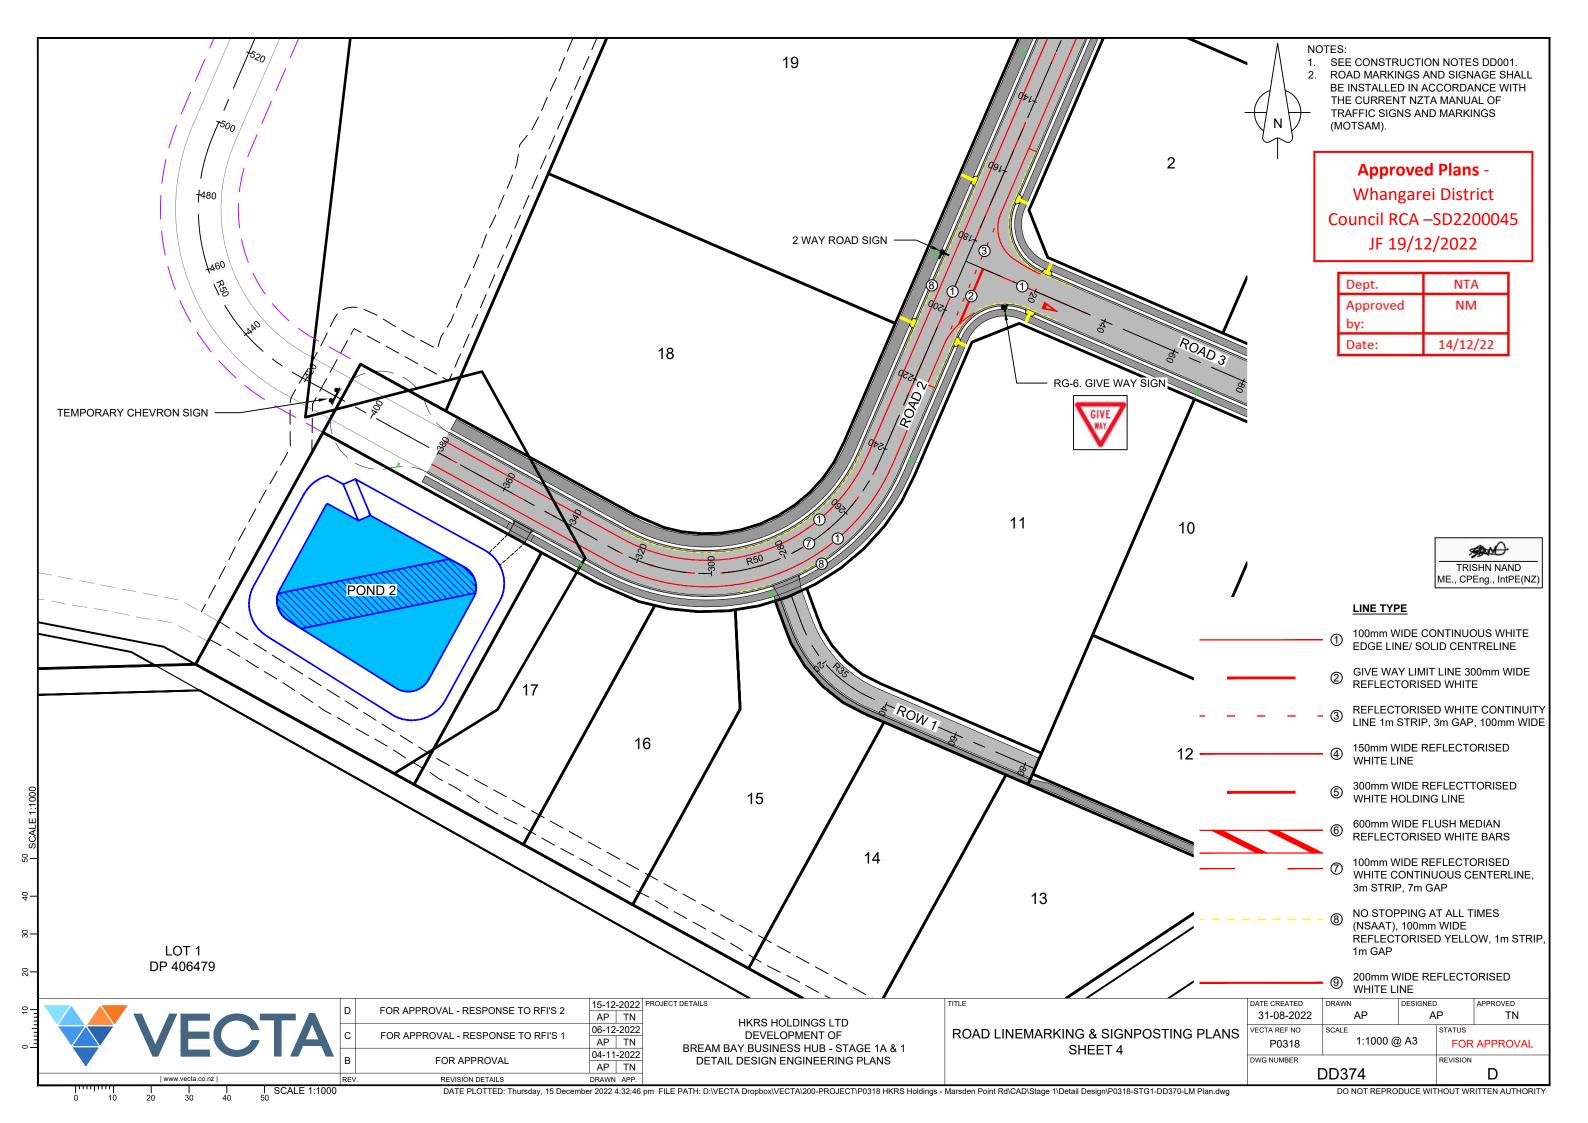


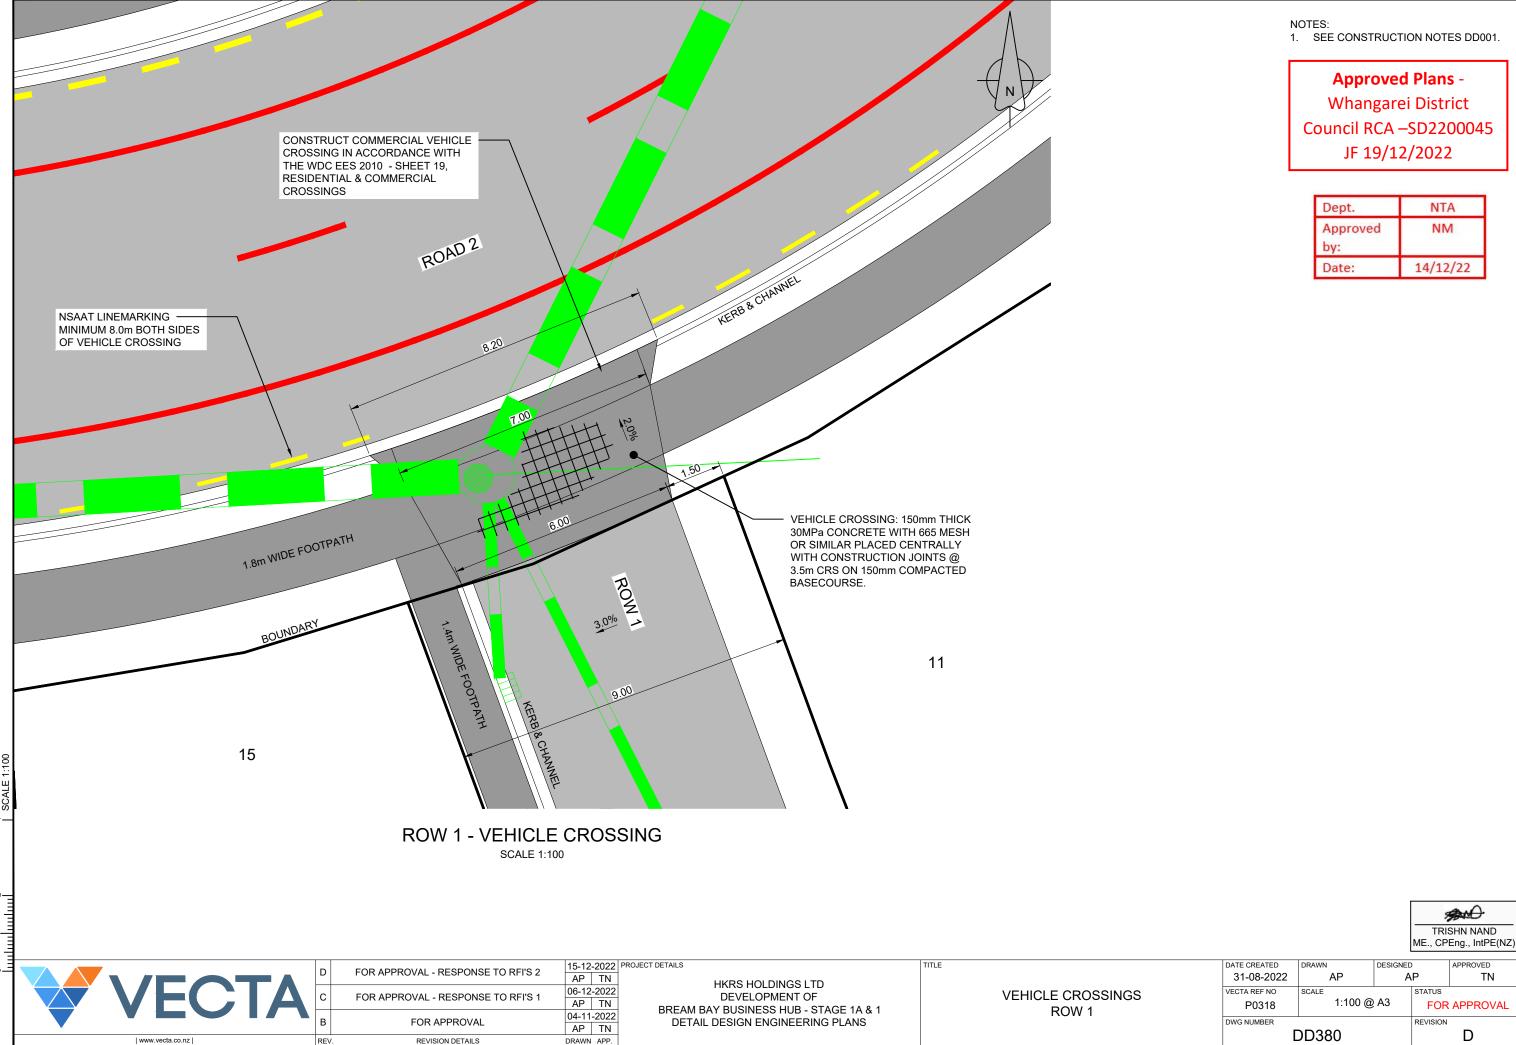

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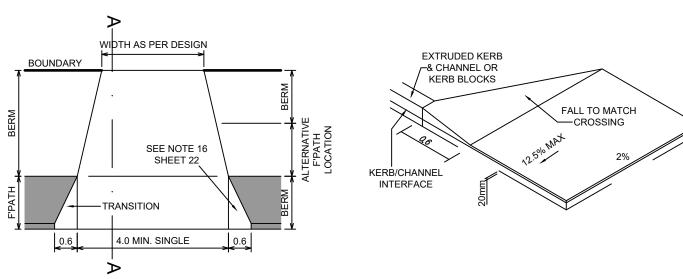
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1. SEE CONSTRUCTION NOTES DD001.

## **Approved Plans -**

Whangarei District Council RCA -SD2200045 JF 19/12/2022

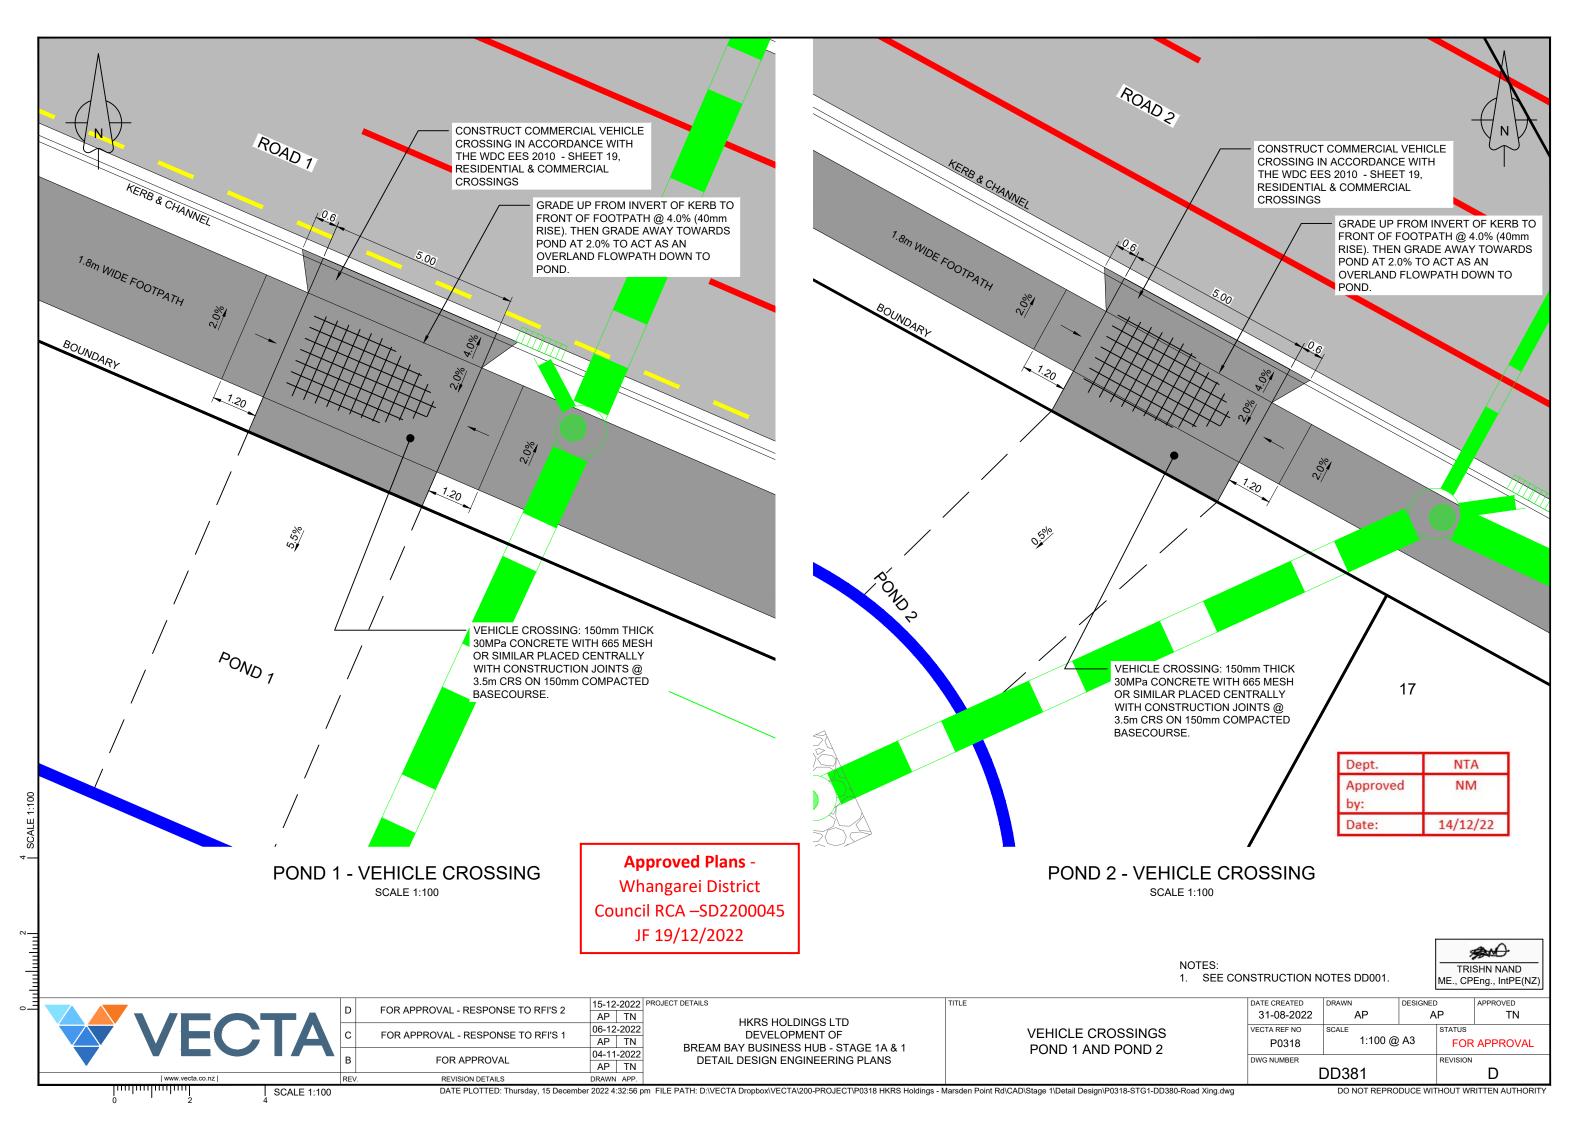

## KERB TRANSITION DETAIL

COMMERCIAL/INDUSTRIAL CROSSINGS - SHEET 19 WDC EES 2010 - NOT TO SCALE


COMMERCIAL/INDUSTRIAL CROSSINGS -SHEET 19 WDC EES 2010 - NOT TO SCALE

- ALL CONCRETE TO BE 30MPa STRENGTH AT 28 DAYS.
   CROSSINGS TO BE CONSTRUCTED TO MATCH EXISTING FOOTPATH AND CHANNEL LEVELS AND BE GRADED TO GIVE SUFFICIENT CLEARANCE TO THE UNDERSIDE OF ALL VEHICLES.
- IF NO FOOTPATH, ALLOWANCE SHALL BE MADE FOR SUCH WITH A 3% CROSSFALL TO THE KERB.
- GRADIENT OF CROSSING NOT TO EXCEED 12.5% (1 IN 8)
- CROSSINGS FOR ALL PRIVATEWAYS SHALL BE COMMERCIAL GRADE (PER SHEET 19)
- EDGES OF FOOTPATH AND BACK OF CHANNEL TO BE SAWCUT.
- ALL CROSSINGS REQUIRE COUNCIL INSPECTION PRIOR TO POURING CONCRETE.
- IF THE EDGE OF THE CROSSING IS WITHIN 1m OF A CRACK OR JOINT IN AN EXISTING FOOTPATH THEN THAT
- SECTION OF FOOTPATH IS TO BE REPLACED.

  COMMERCIAL AND INDUSTRIAL CHANNELS TO BE REINFORCED WITH AN EXTENSION OF THE 668 MESH.

  WHERE A STREET SUMP IS LOCATED WITHIN THE PROPOSED CROSSING, THE SUMP SHALL BE RELOCATED

  TO THE SIDE OF THE CROSSING AND BE RECONNECTED TO THE COUNCIL STORMWATER SYSTEM.
- 11. REFER TO SHEET 16 FOR VEHICLE CROSSINGS OVER A DRAINAGE SWALE.

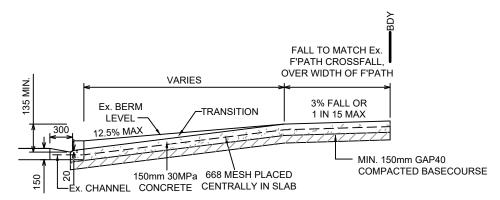

### **CROSSING SECTION A-A**


COMMERCIAL/INDUSTRIAL CROSSINGS -SHEET 19 WDC EES 2010 - NOT TO SCALE





FOR APPROVAL


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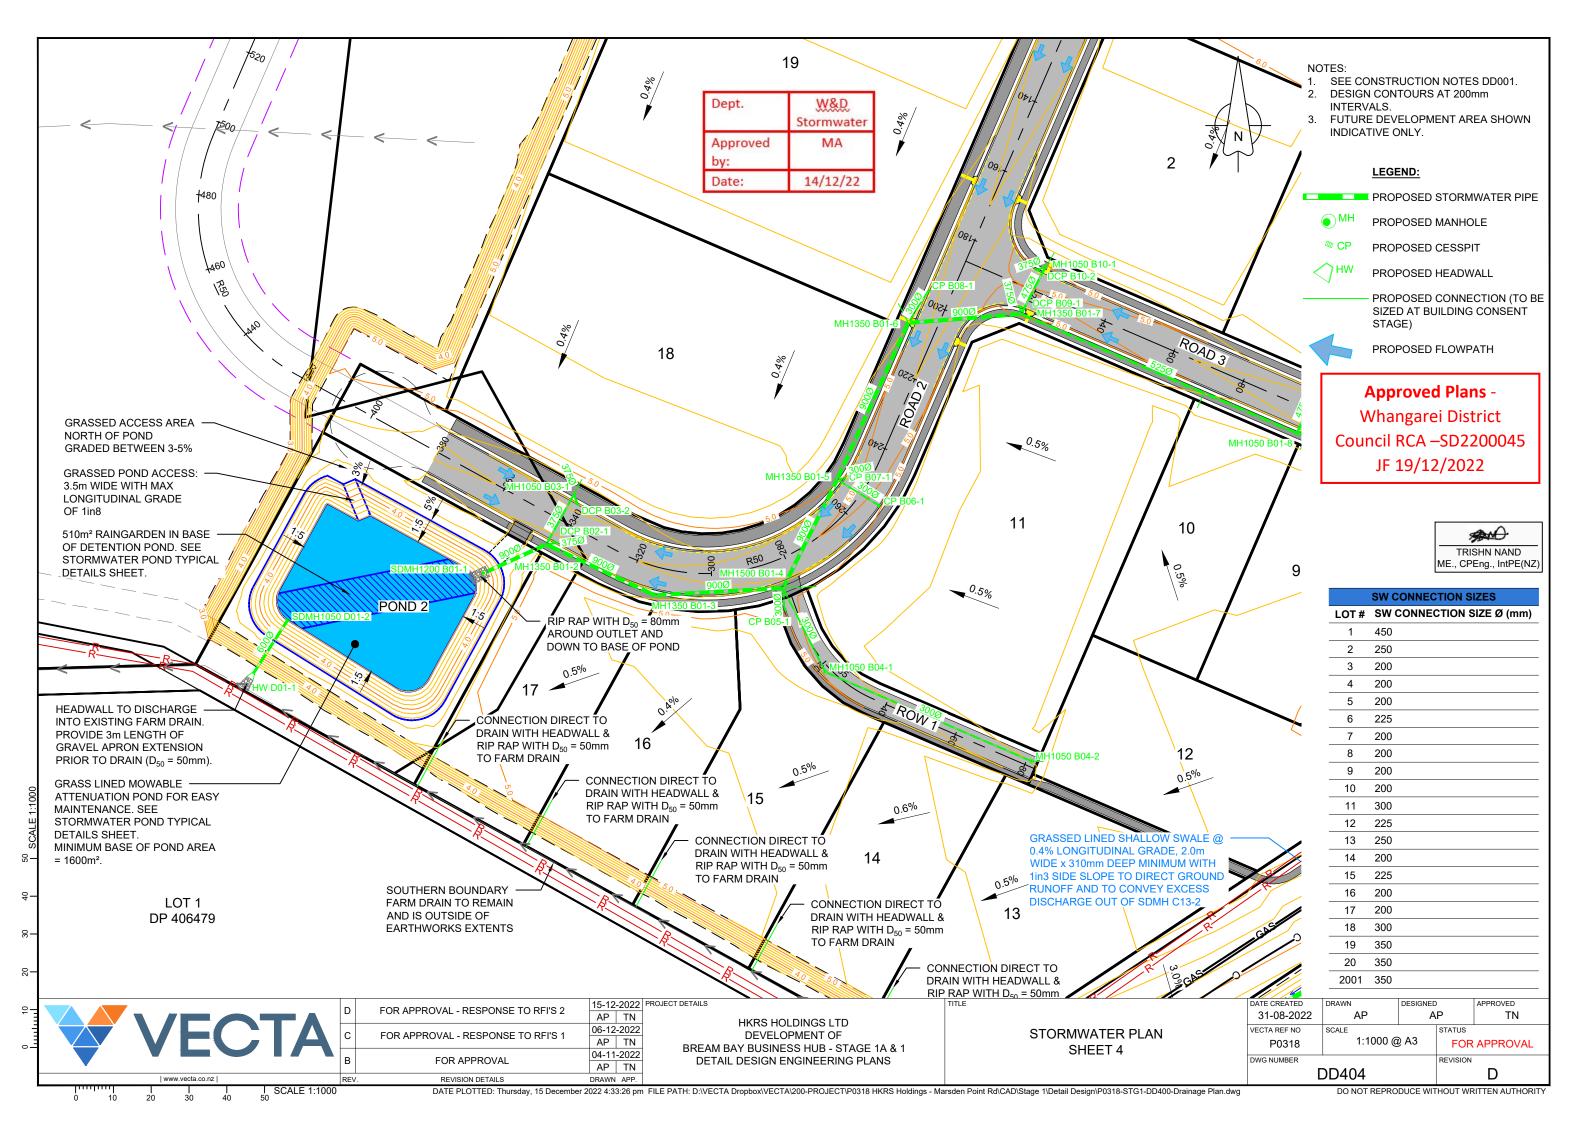
	FOR APPROVAL - RESPONSE TO RFI'S 2	15-12-2022 AP TN 06-12-2022	HKRS HOLDINGS LTD	TITLE	31-08-2022 VECTA REF NO	DRAWN AP	DESIGNED AP
VECIA	FOR APPROVAL - RESPONSE TO RFI'S 1	AP TN 04-11-2022	DEVELOPMENT OF BREAM BAY BUSINESS HUB - STAGE 1A & 1	VEHICLE CROSSING DETAILS	P0318	AS SHOW	N @ A3
В	FOR APPROVAL	AP TN	DETAIL DESIGN ENGINEERING PLANS		DWG NUMBER	DD385	RI
www.vecta.co.nz   RE	V. REVISION DETAILS	DRAWN APP.				DD303	




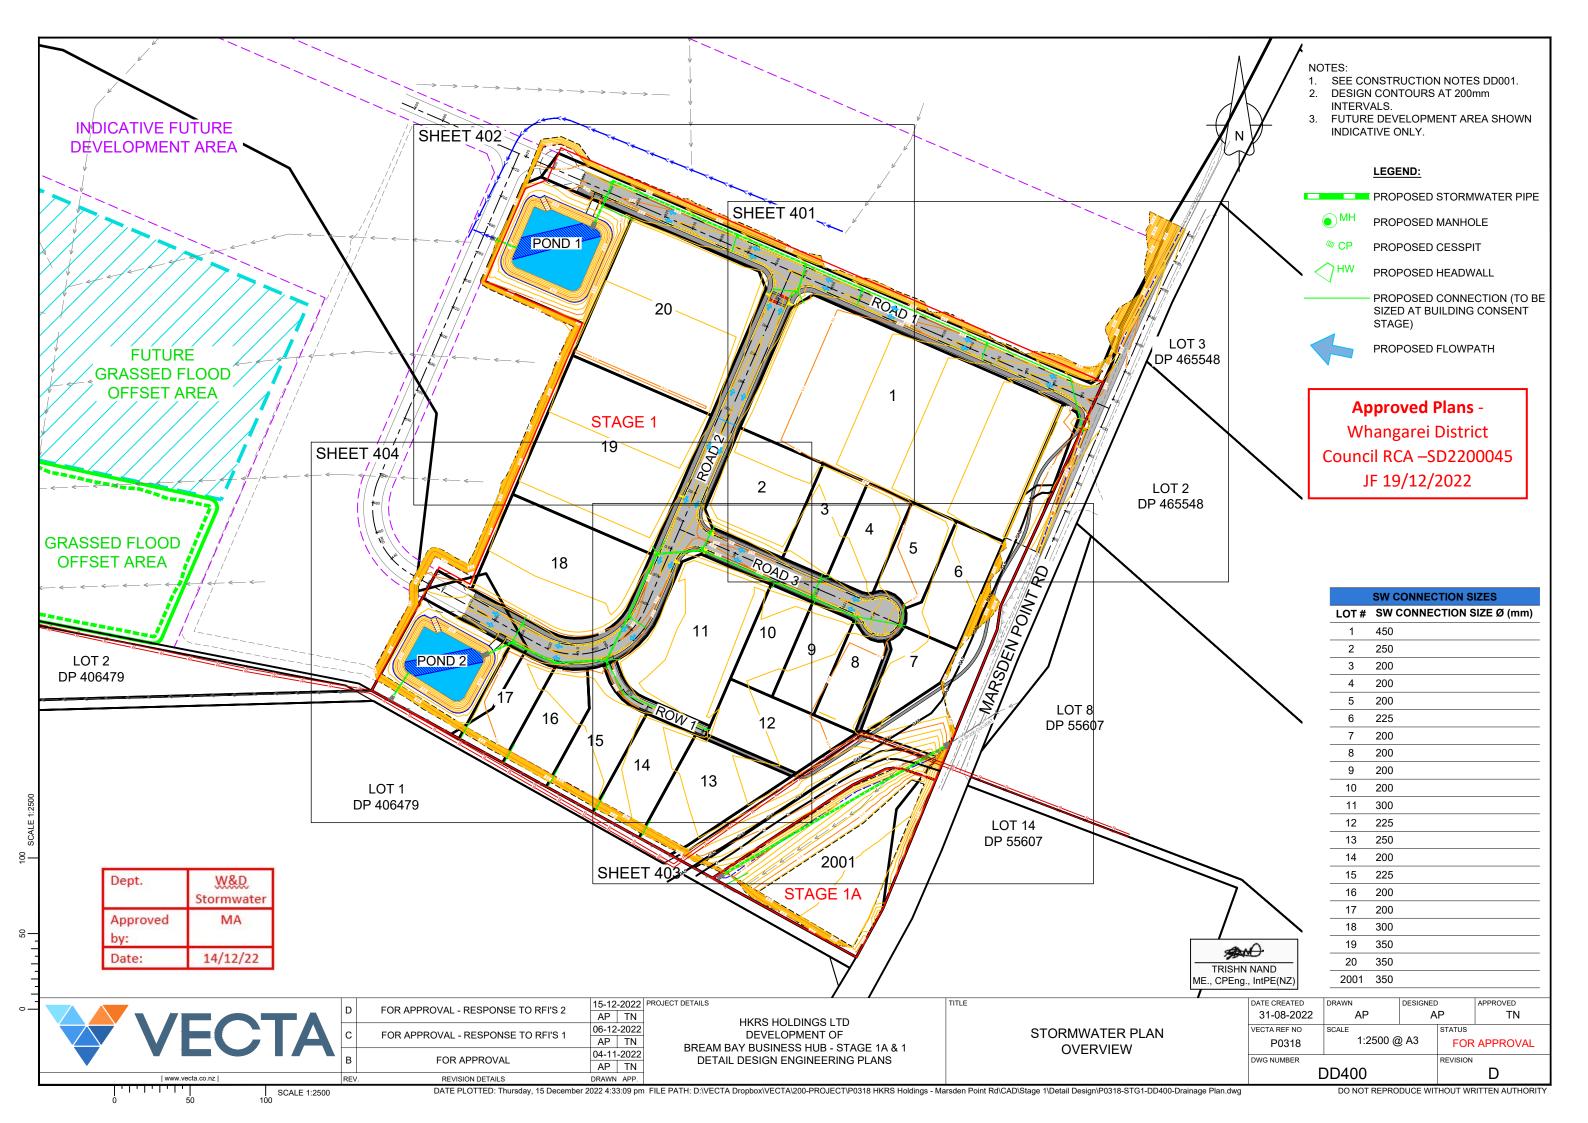


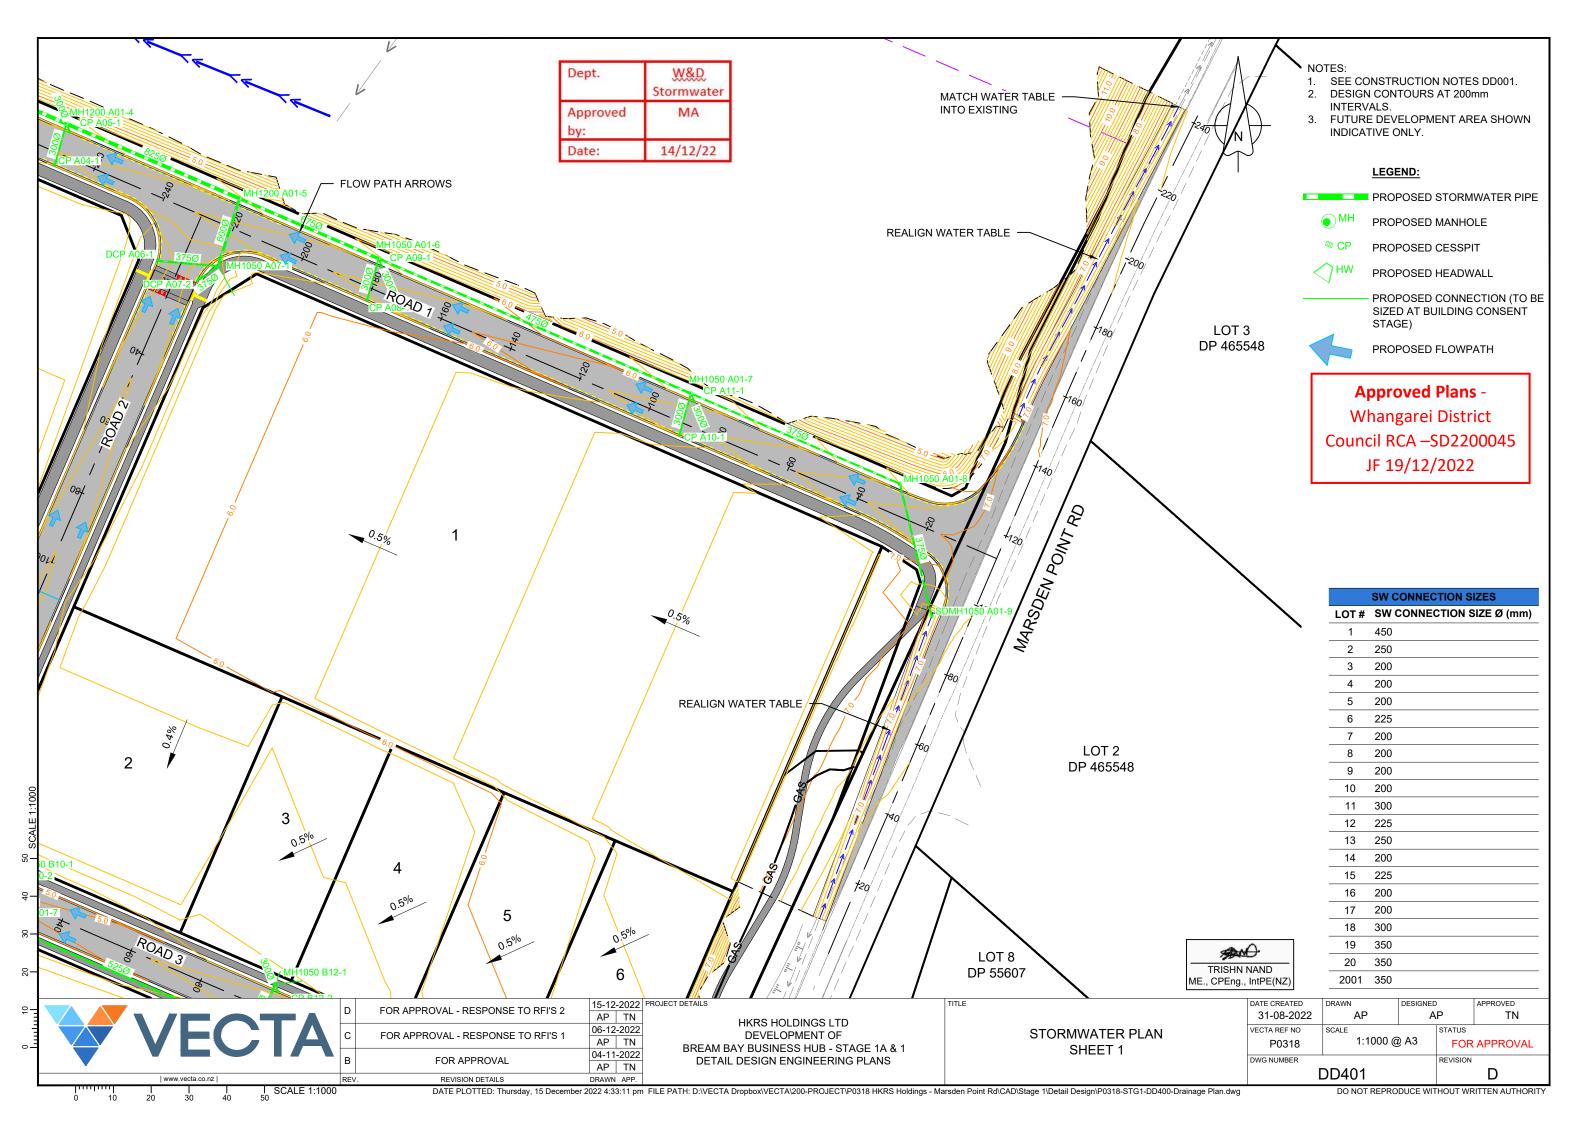


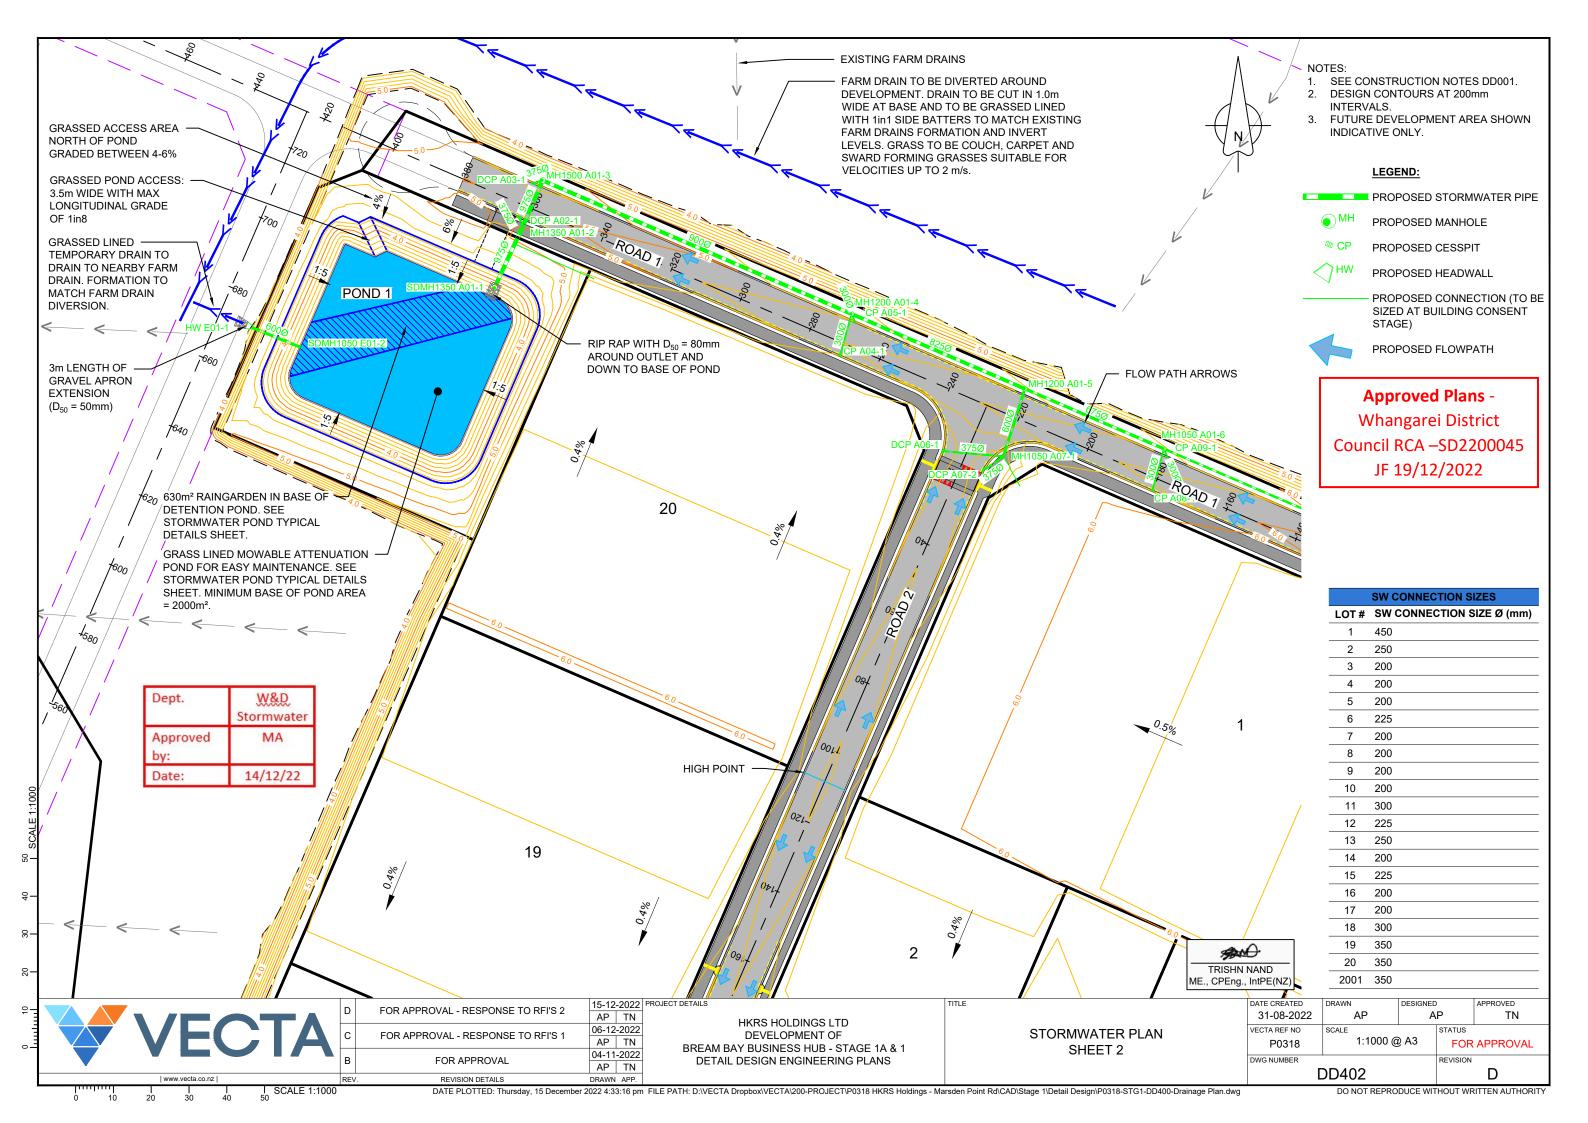


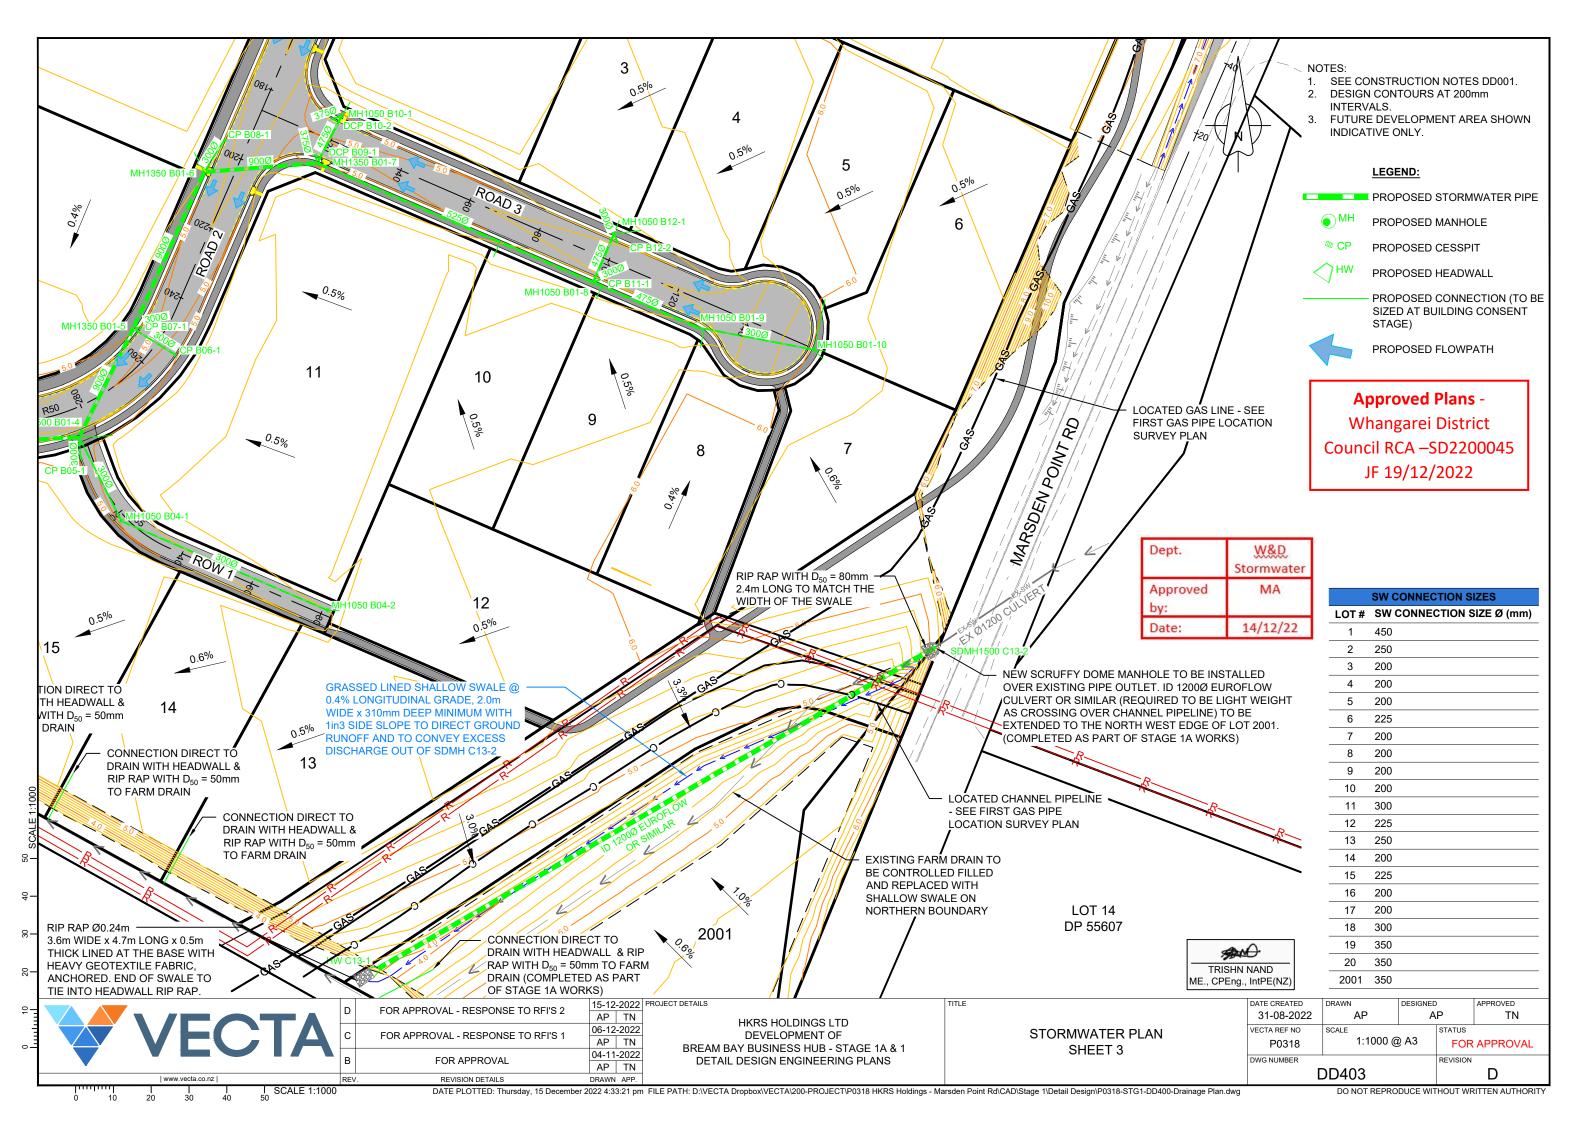


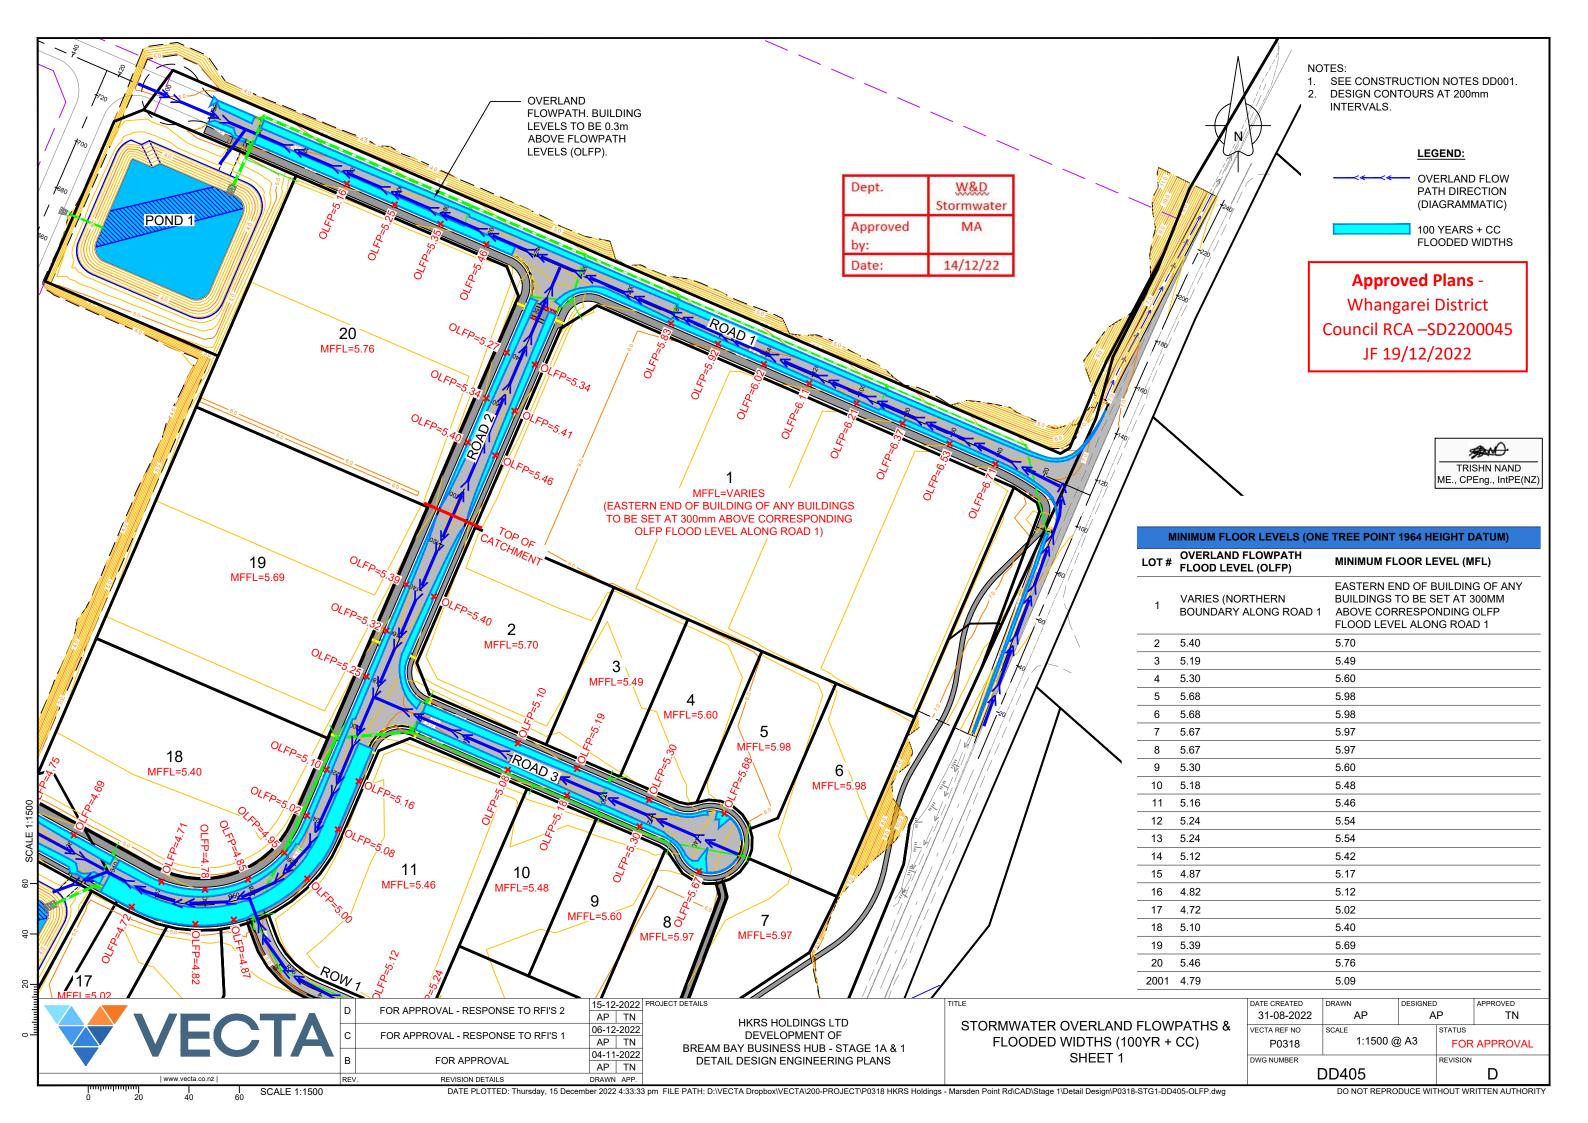

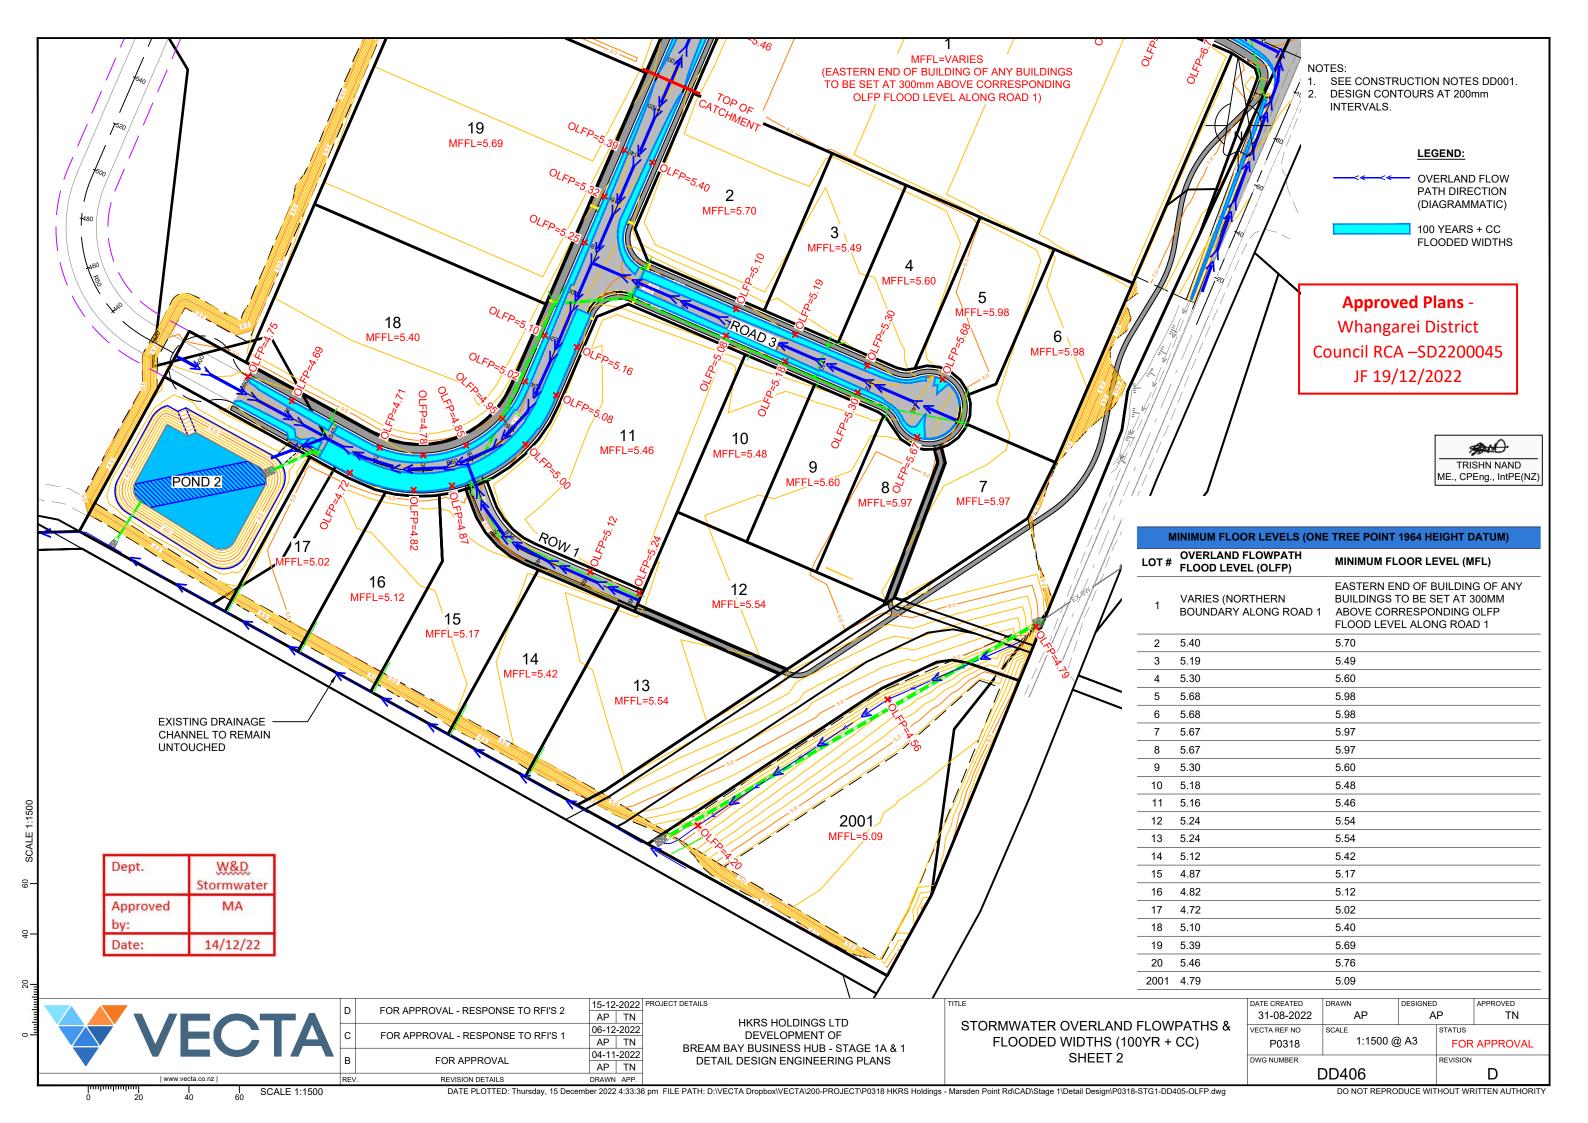

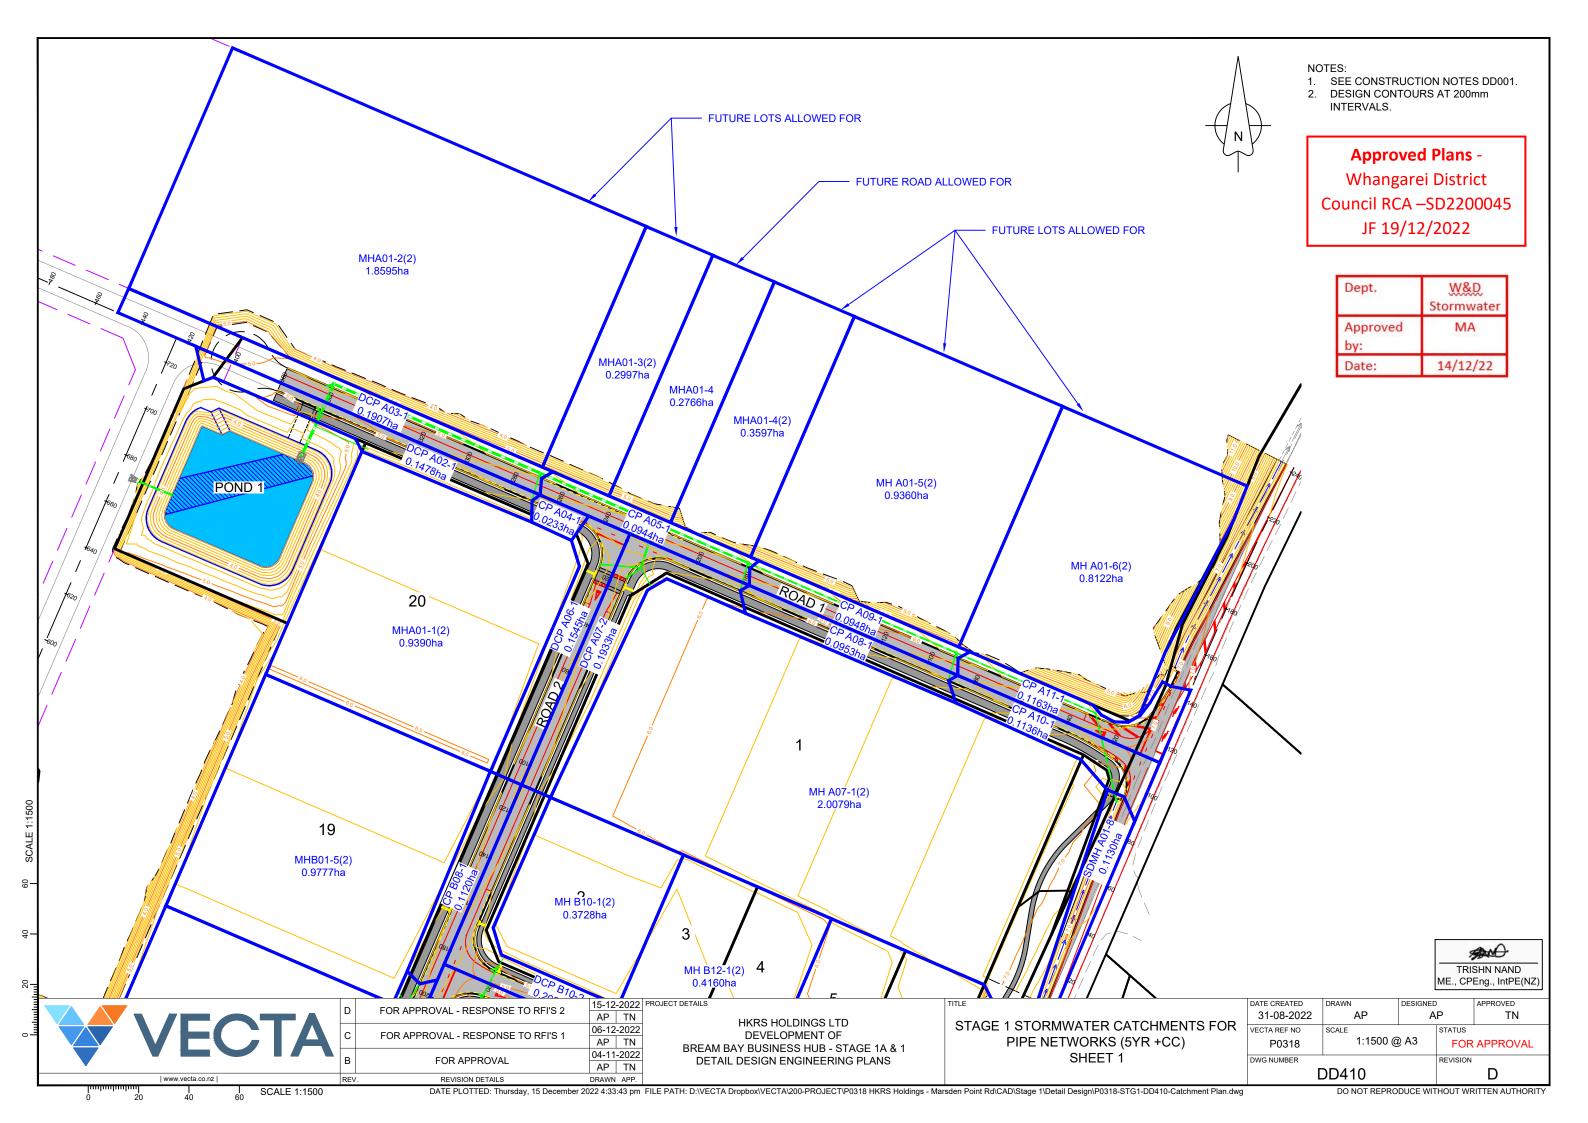

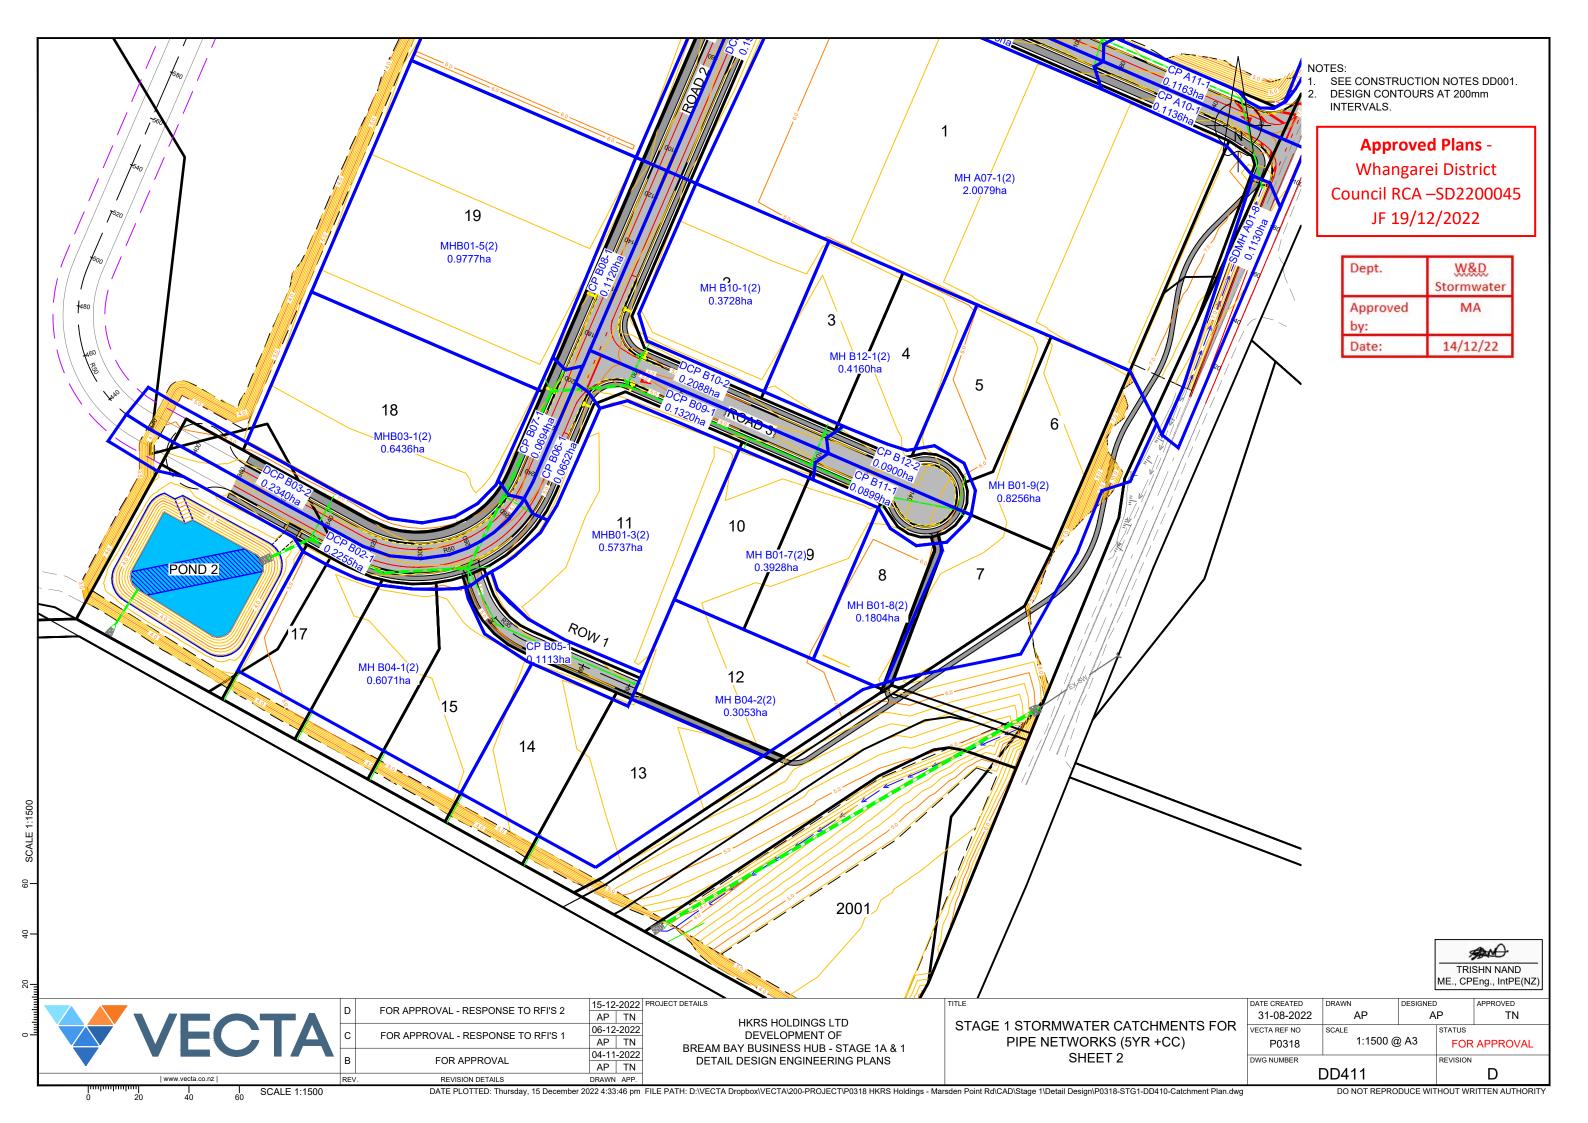

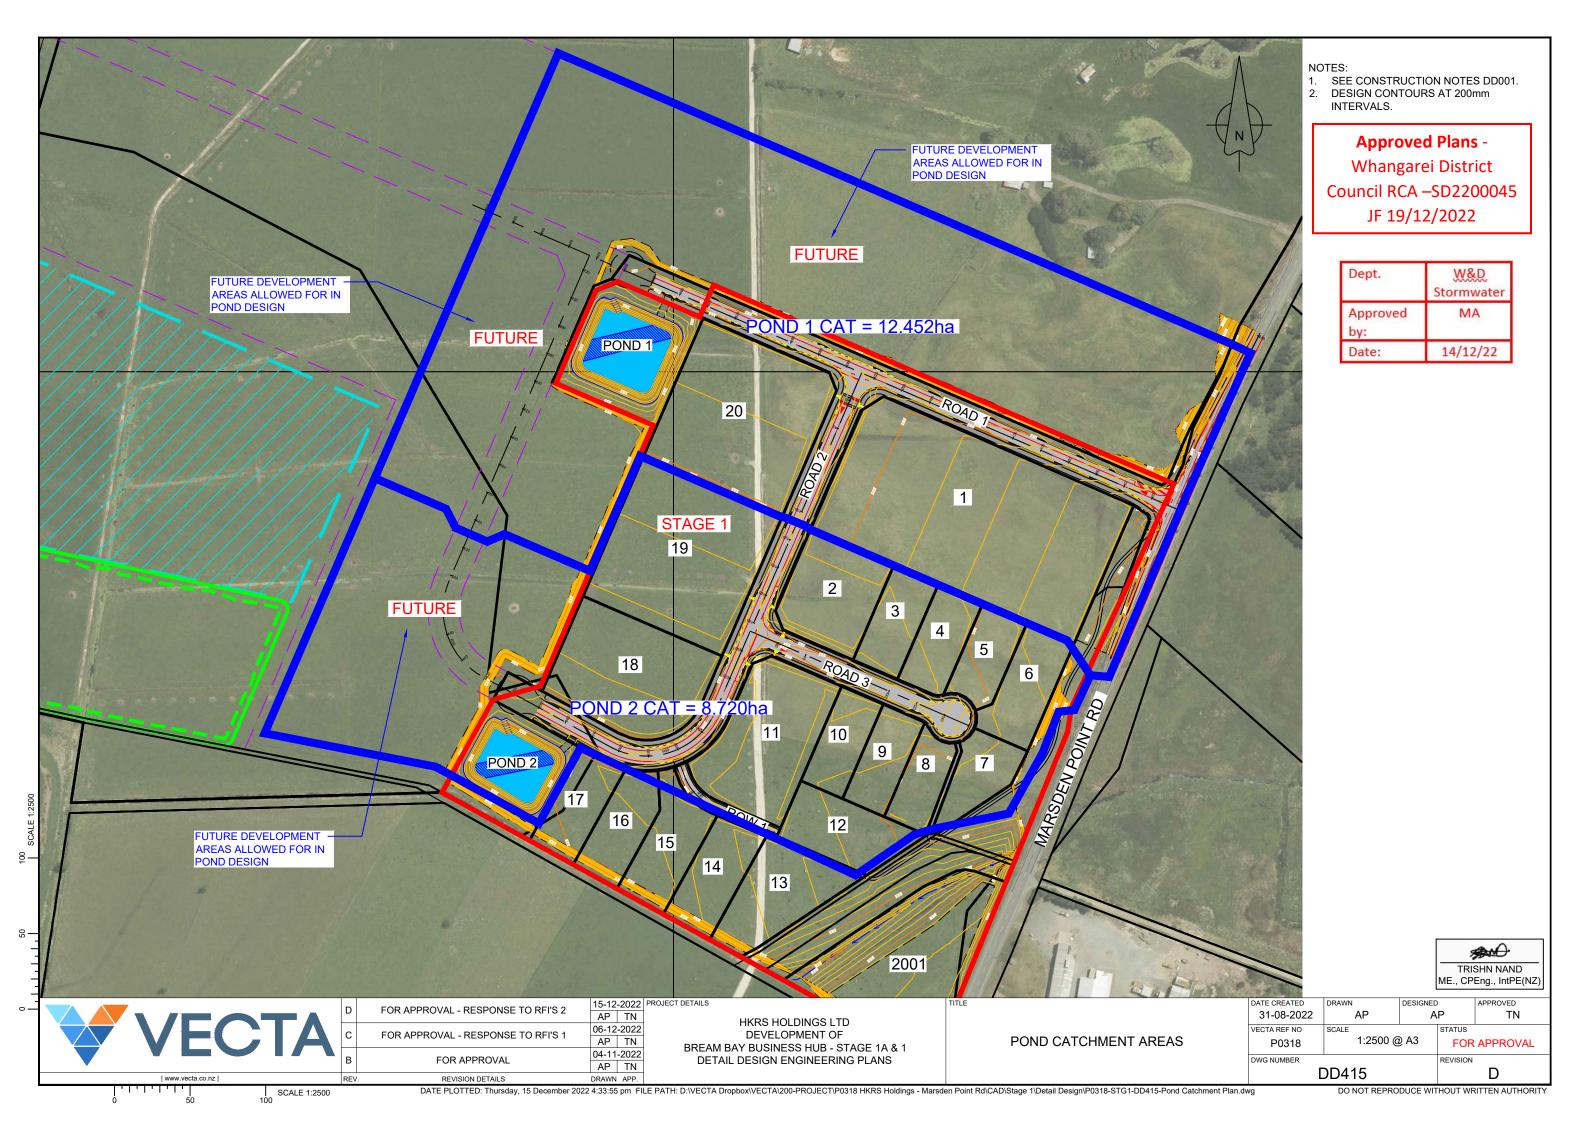

LINE A01

Levels

Chainage

Finished Surface

#### **STORMWATER DESIGN NOTE:**

STORMWATER PIPE NETWORK DESIGNED FOR 1:5 ARI (YEARS) + CLIMATE CHANGE. FREEBOARD OF 0.3m ACHIEVED THROUGHOUT NETOWRK.




15-12-2022 PROJECT DETAILS FOR APPROVAL - RESPONSE TO RFI'S 2 AP TN 31-08-2022 HKRS HOLDINGS LTD 06-12-2022 STORMWATER LONGSECTIONS VECTA REF NO SCALE 1:1000(H) @ A3 DEVELOPMENT OF FOR APPROVAL - RESPONSE TO RFI'S 1 AP TN FOR APPROVAL P0318 1:200(V) @ A3 BREAM BAY BUSINESS HUB - STAGE 1A & 1 (SHEET 1) 04-11-2022 DETAIL DESIGN ENGINEERING PLANS FOR APPROVAL REVISION DETAILS DRAWN APP. DO NOT REPRODUCE WITHOUT WRITTEN AUTHORITY

1. SEE CONSTRUCTION NOTES DD001.

# **Approved Plans -**

Whangarei District Council RCA -SD2200045 JF 19/12/2022

Dept.	<u>W&amp;D</u> Stormwater
Approved by:	MA
Date:	14/12/22

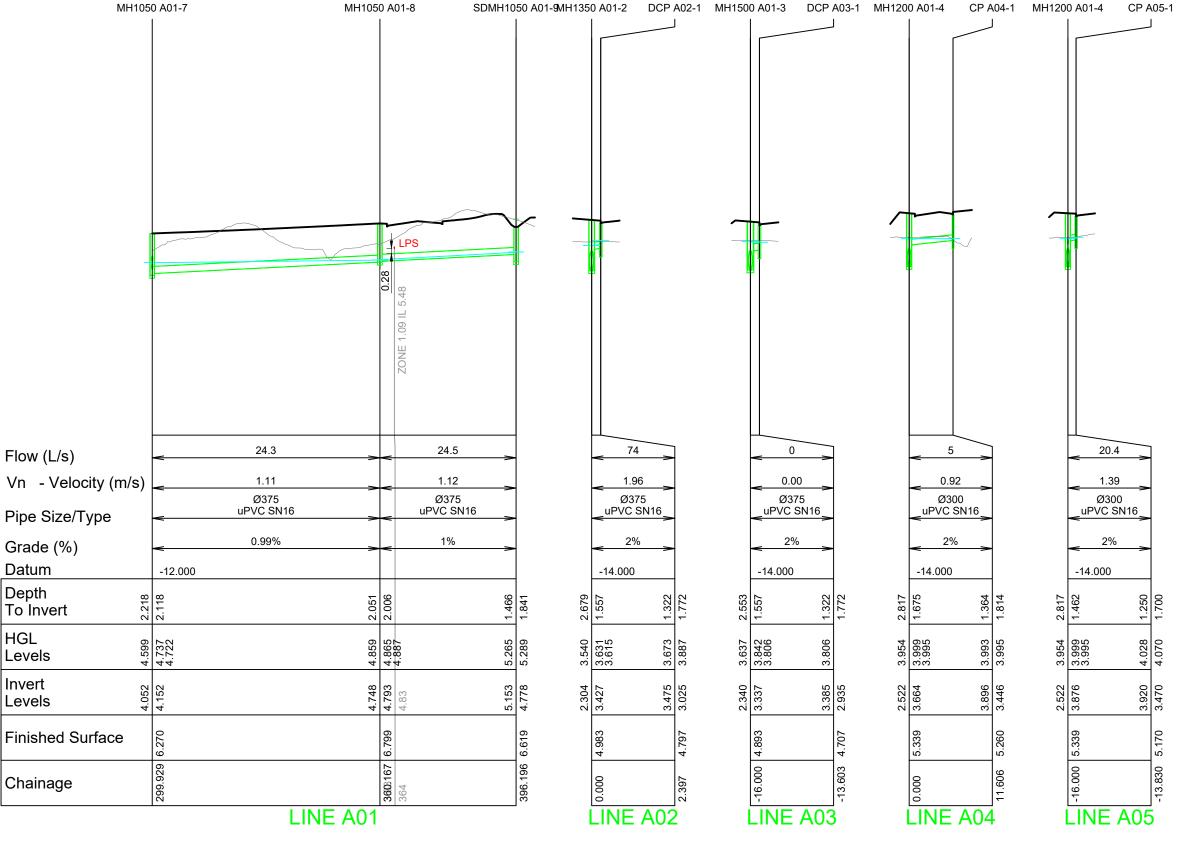

#### **STORMWATER DESIGN NOTE:**

STORMWATER PIPE NETWORK DESIGNED FOR 1:5 ARI (YEARS) + CLIMATE CHANGE. FREEBOARD OF 0.3m ACHIEVED THROUGHOUT NETOWRK.



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	7						I
		w	ww.vecta.co	.nz			R
0	10	20	30	40	50	SCALE 1:1000	

Flow (L/s)

Grade (%) Datum

Depth To Invert

HGL Levels

Invert

Levels

Chainage

D	FOR APPROVAL - RESPONSE TO RFI'S 2	15-12	-2022	PROJECT DETAILS
וט	FOR AFPROVAL - RESPONSE TO RF13 2	AP	TN	
(	FOR APPROVAL - RESPONSE TO RFI'S 1	06-12	-2022	
	FOR AFFROVAL - RESPONSE TO KFIS T	AP	TN	BRFA
В	FOR APPROVAL	04-11	-2022	DF.
	TORAFFROVAL	AP	TN	
DEV	DEVISION DETAILS	DD A MA	A DD	


HKRS HOLDINGS LTD DEVELOPMENT OF BREAM BAY BUSINESS HUB - STAGE 1A & 1 DETAIL DESIGN ENGINEERING PLANS

STORMWATER LONGSECTIONS (SHEET 2)

DATE CREATED	DRAWN	DESIGNED		APPROVED
31-08-2022	AP	А	P	TN
VECTA REF NO	SCALE 1:1000(H)	@ Δ3	STATUS	•
P0318	1:200(V) (		FOR	APPROVAL
	1.200(V) (	w As		
DWG NUMBER			REVISION	
Г		D		
-	DD421			




1. SEE CONSTRUCTION NOTES DD001.

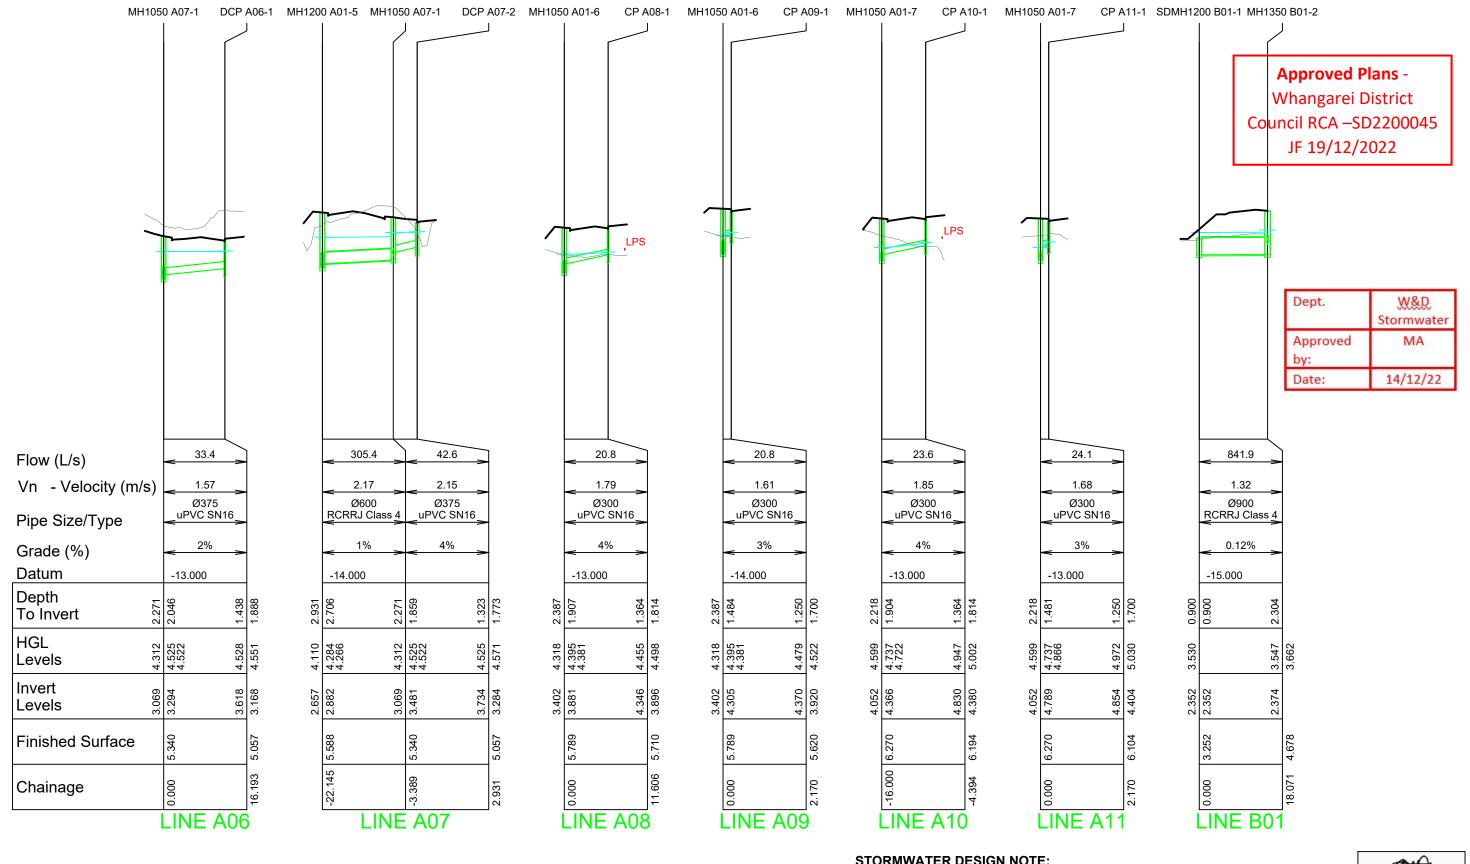

## **STORMWATER DESIGN NOTE:**

STORMWATER PIPE NETWORK DESIGNED FOR 1:5 ARI (YEARS) + CLIMATE CHANGE. FREEBOARD OF 0.3m ACHIEVED THROUGHOUT NETOWRK.

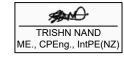



n I	FOR APPROVAL - RESPONSE TO RFI'S 2	15-12-2022		
١	FOR AFPROVAL - RESPONSE TO RF13 2	AP	TN	
С	FOR APPROVAL - RESPONSE TO RFI'S 1	06-12	-2022	
	FOR AFFROVAL - RESPONSE TO KFIS T	AP	TN	
В	FOR APPROVAL	04-11	-2022	
Ь	FOR APPROVAL		TN	

HKRS HOLDINGS LTD DEVELOPMENT OF BREAM BAY BUSINESS HUB - STAGE 1A & 1 DETAIL DESIGN ENGINEERING PLANS

STORMWATER LONGSECTIONS (SHEET 3)

DATE CREATED 31-08-2022	DRAWN AP	DESIGNED	P	APPROVED TN
VECTA REF NO P0318	SCALE 1:1000(H) 1:200(V) (		STATUS FOR	APPROVAL
DWG NUMBER DD422			REVISION	D

Dept.

Date:

Approved


1. SEE CONSTRUCTION NOTES DD001.

**Approved Plans -**Whangarei District Council RCA -SD2200045 JF 19/12/2022

W&D

Stormwater MA

14/12/22

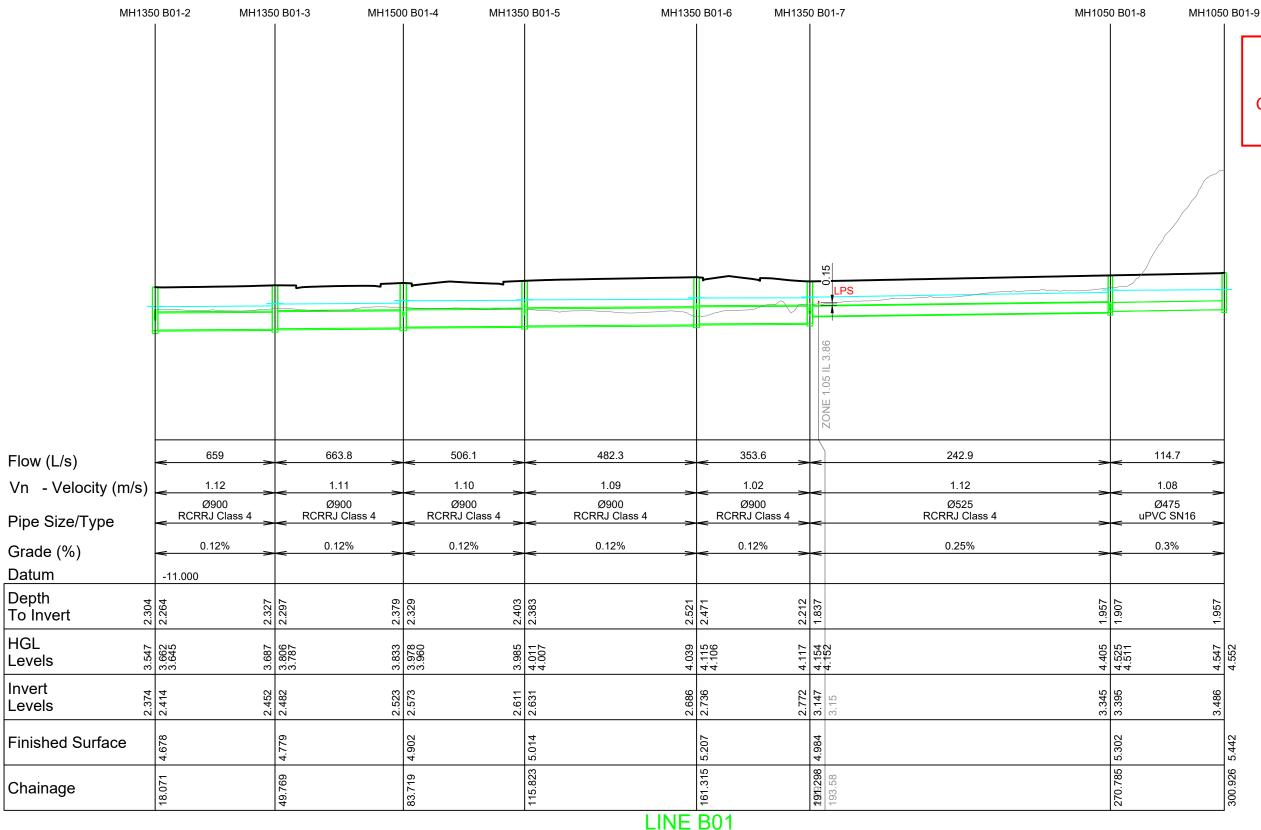



#### **STORMWATER DESIGN NOTE:**

STORMWATER PIPE NETWORK DESIGNED FOR 1:5 ARI (YEARS) + CLIMATE CHANGE. FREEBOARD OF 0.3m ACHIEVED THROUGHOUT NETOWRK.




15-12-2022 PROJECT DETAILS FOR APPROVAL - RESPONSE TO RFI'S 2 AP TN 31-08-2022 HKRS HOLDINGS LTD 06-12-2022 STORMWATER LONGSECTIONS VECTA REF NO SCALE 1:1000(H) @ A3 DEVELOPMENT OF FOR APPROVAL - RESPONSE TO RFI'S 1 AP TN FOR APPROVAL P0318 1:200(V) @ A3 BREAM BAY BUSINESS HUB - STAGE 1A & 1 (SHEET 4) 04-11-2022 DETAIL DESIGN ENGINEERING PLANS FOR APPROVAL **DD423** REVISION DETAILS DRAWN APP.

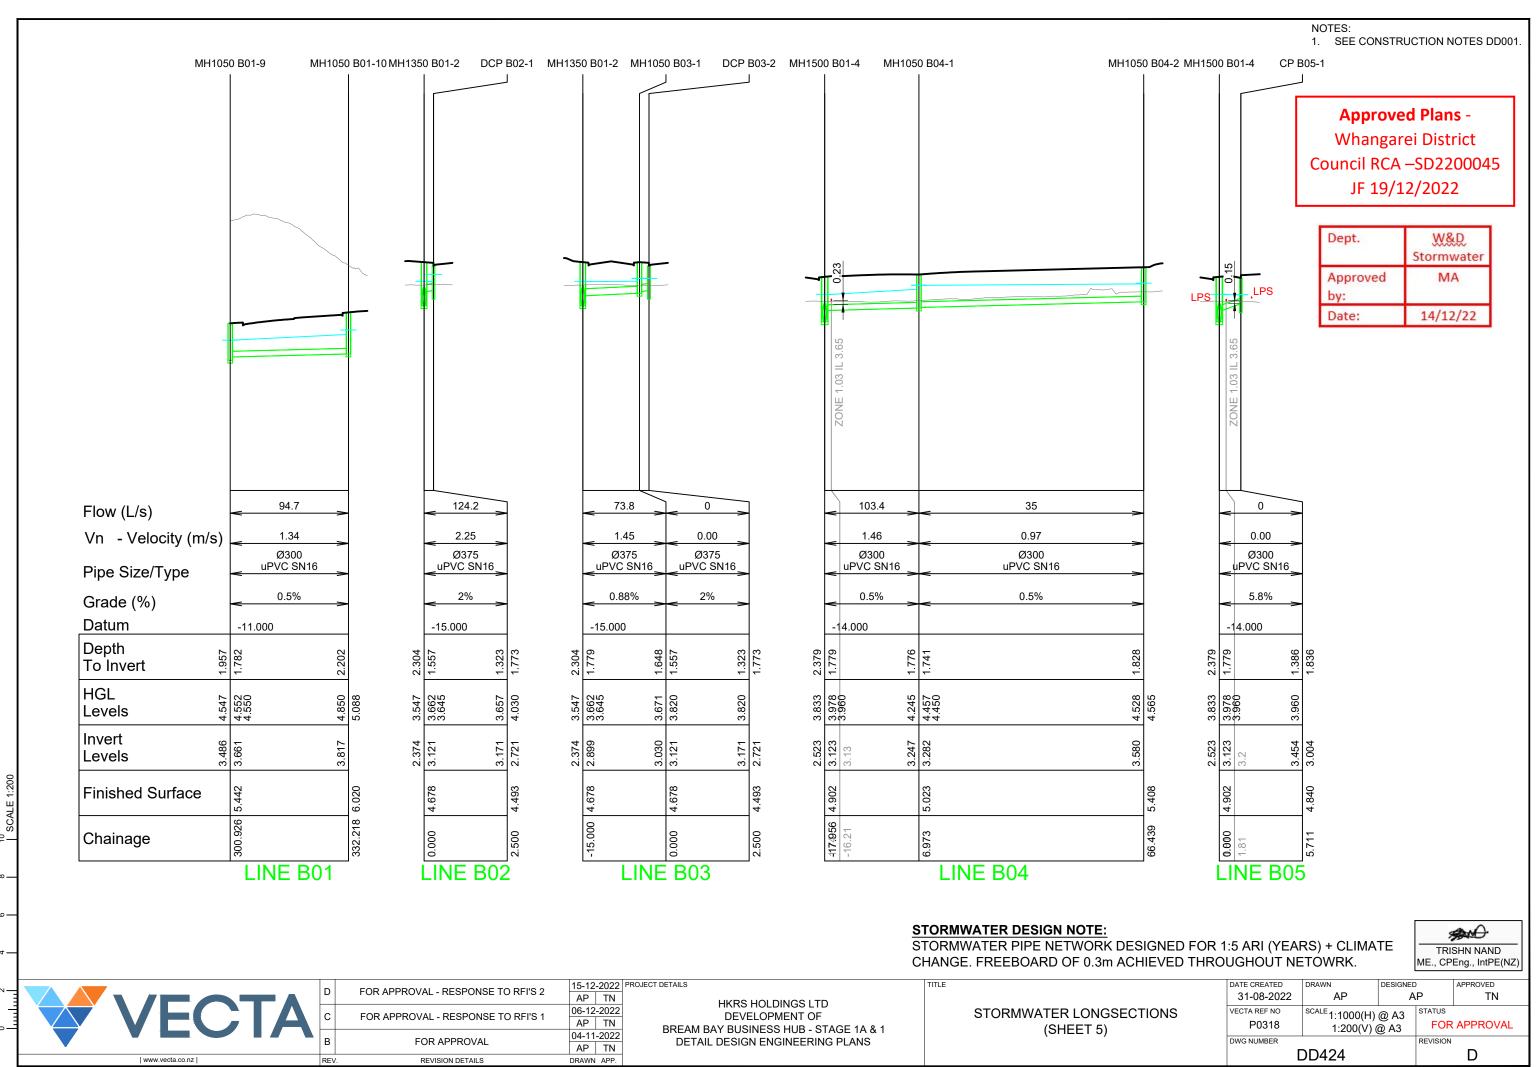

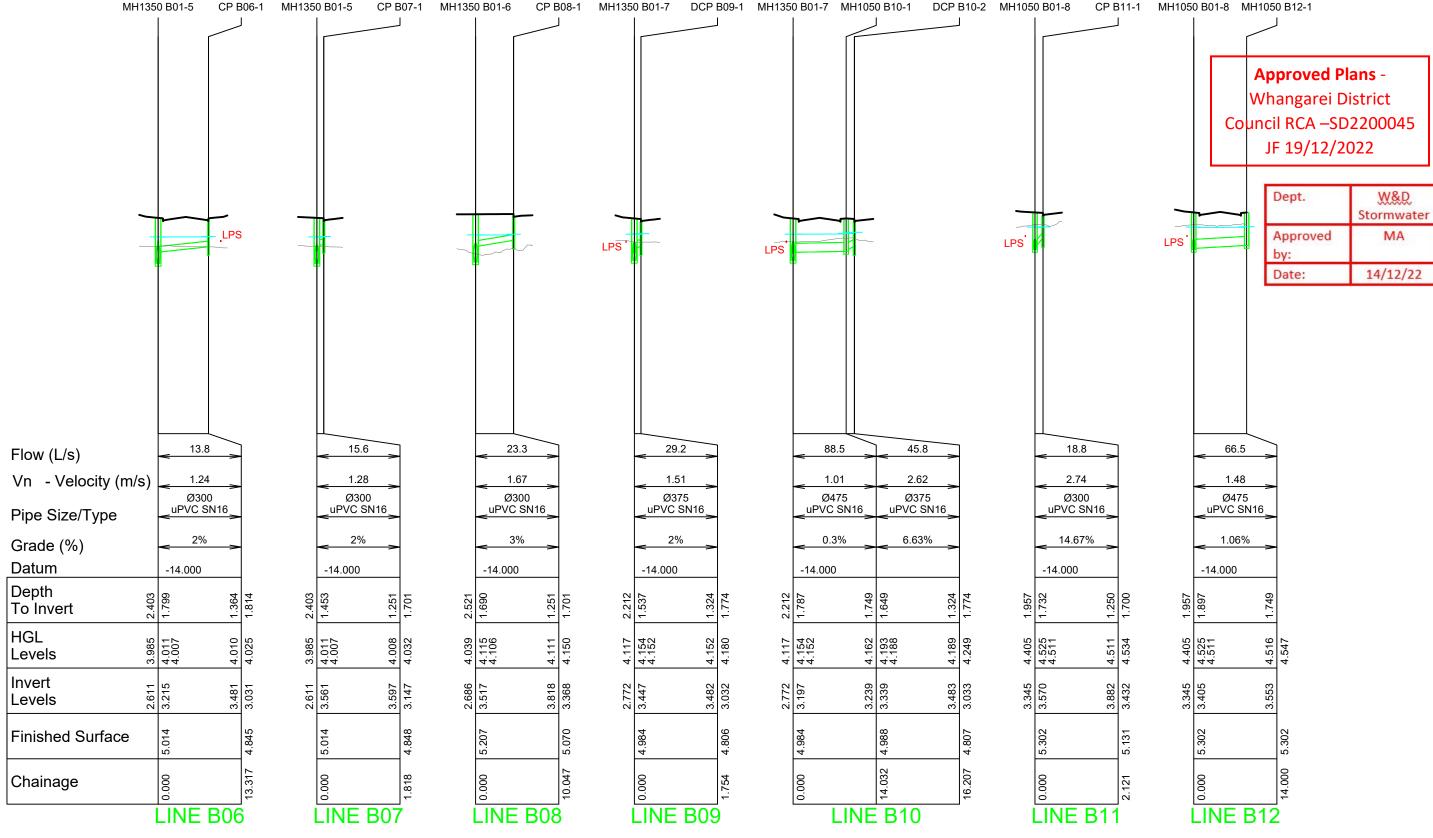

**STORMWATER DESIGN NOTE:** 

STORMWATER PIPE NETWORK DESIGNED FOR 1:5 ARI (YEARS) + CLIMATE CHANGE. FREEBOARD OF 0.3m ACHIEVED THROUGHOUT NETOWRK.

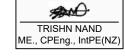





D	FOR APPROVAL - RESPONSE TO RFI'S 2	15-12	-2022	F
ט	FOR AFPROVAL - RESPONSE TO RF13 2	AP	TN	
С	FOR APPROVAL - RESPONSE TO RFI'S 1	06-12	-2022	
C	FOR AFFROVAL - RESPONSE TO KFIS T	AP	TN	
В	FOR APPROVAL	04-11	-2022	
В	FOR APPROVAL	AP	TN	


HKRS HOLDINGS LTD DEVELOPMENT OF BREAM BAY BUSINESS HUB - STAGE 1A & 1 DETAIL DESIGN ENGINEERING PLANS


STORMWATER LONGSECTIONS (SHEET 6)


DATE CREATED	DRAWN	DESIGNED	)	APPROVED	
31-08-2022	AP	Α	P	TN	
VECTA REF NO	SCALE 1:1000(H)	@ <b>∆</b> 3	STATUS		
P0318	1:200(V) @ A3		FOR APPROVAL		
DWG NUMBER			REVISION		
	DD425			D	

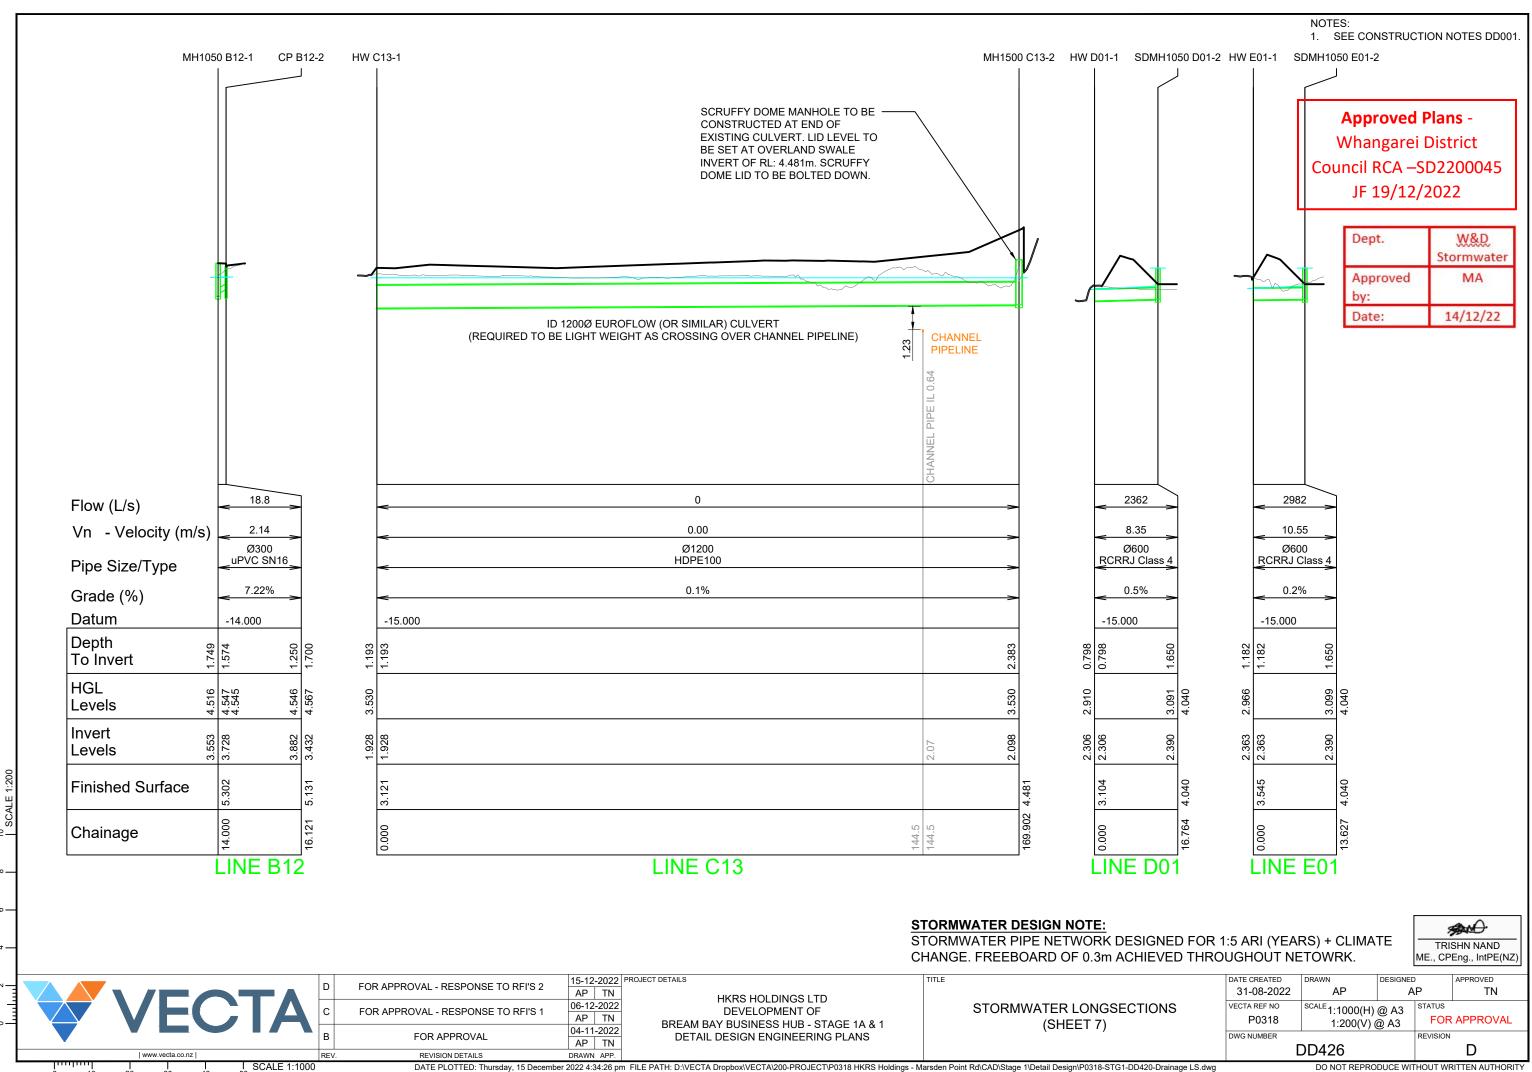


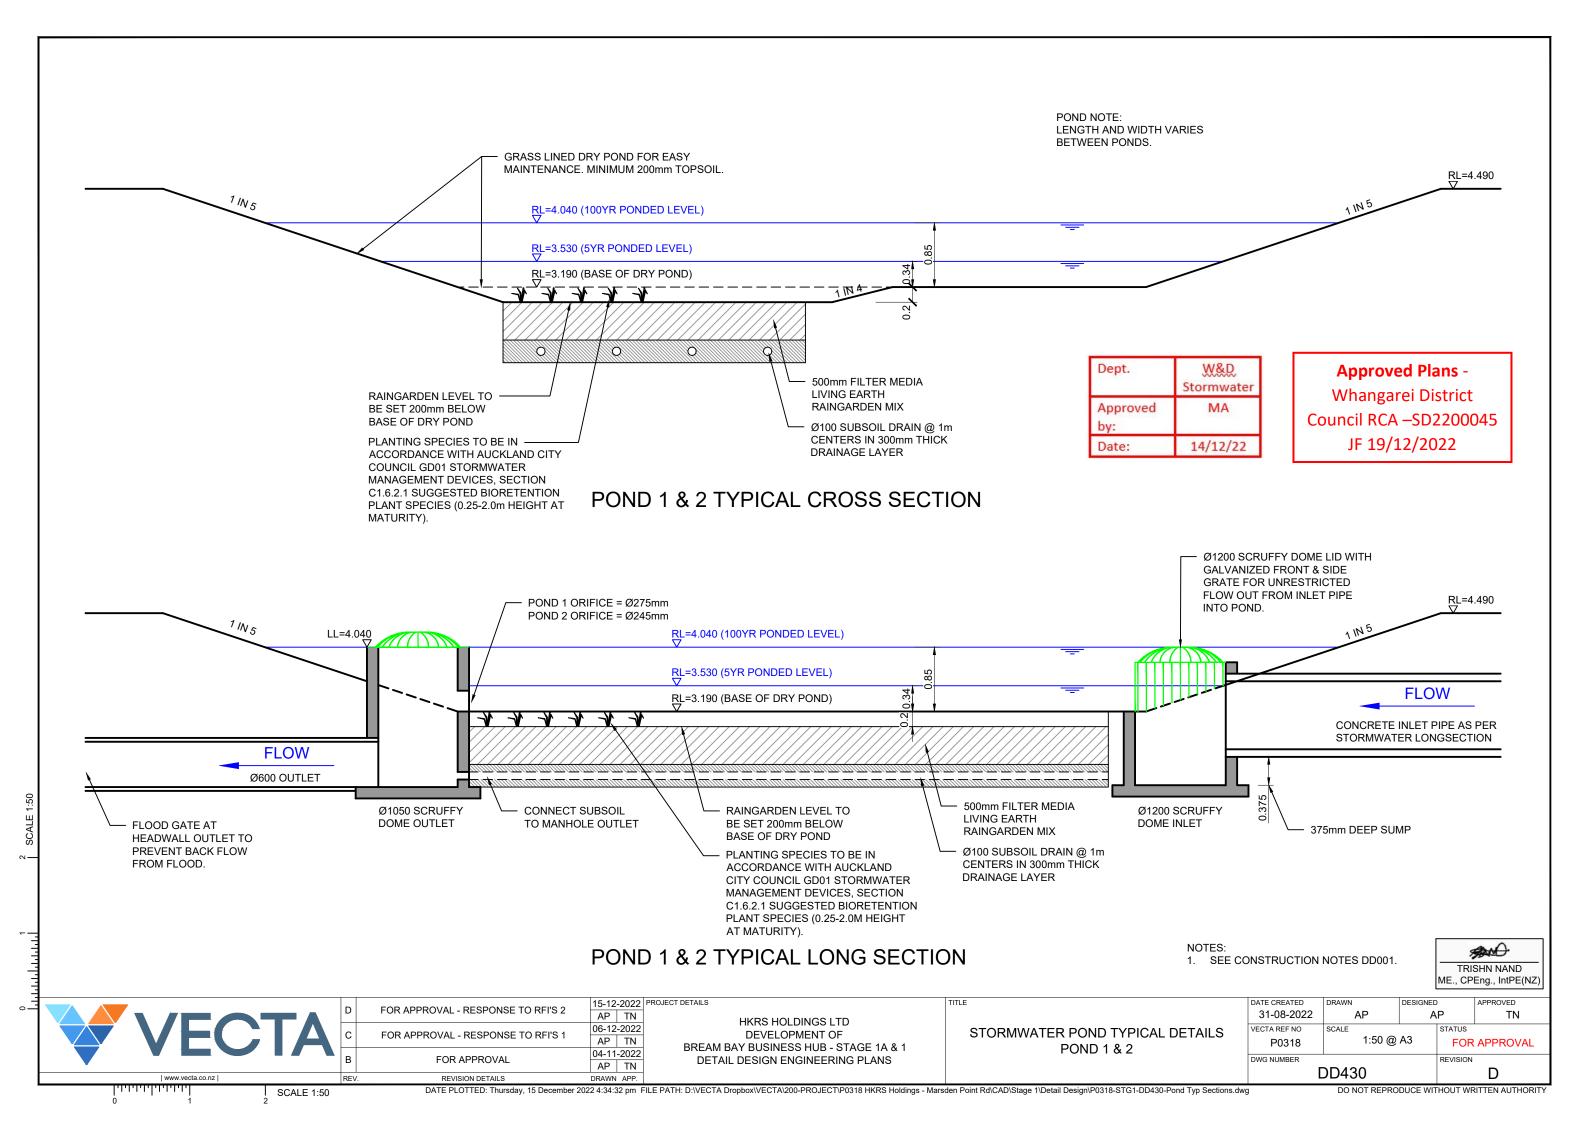


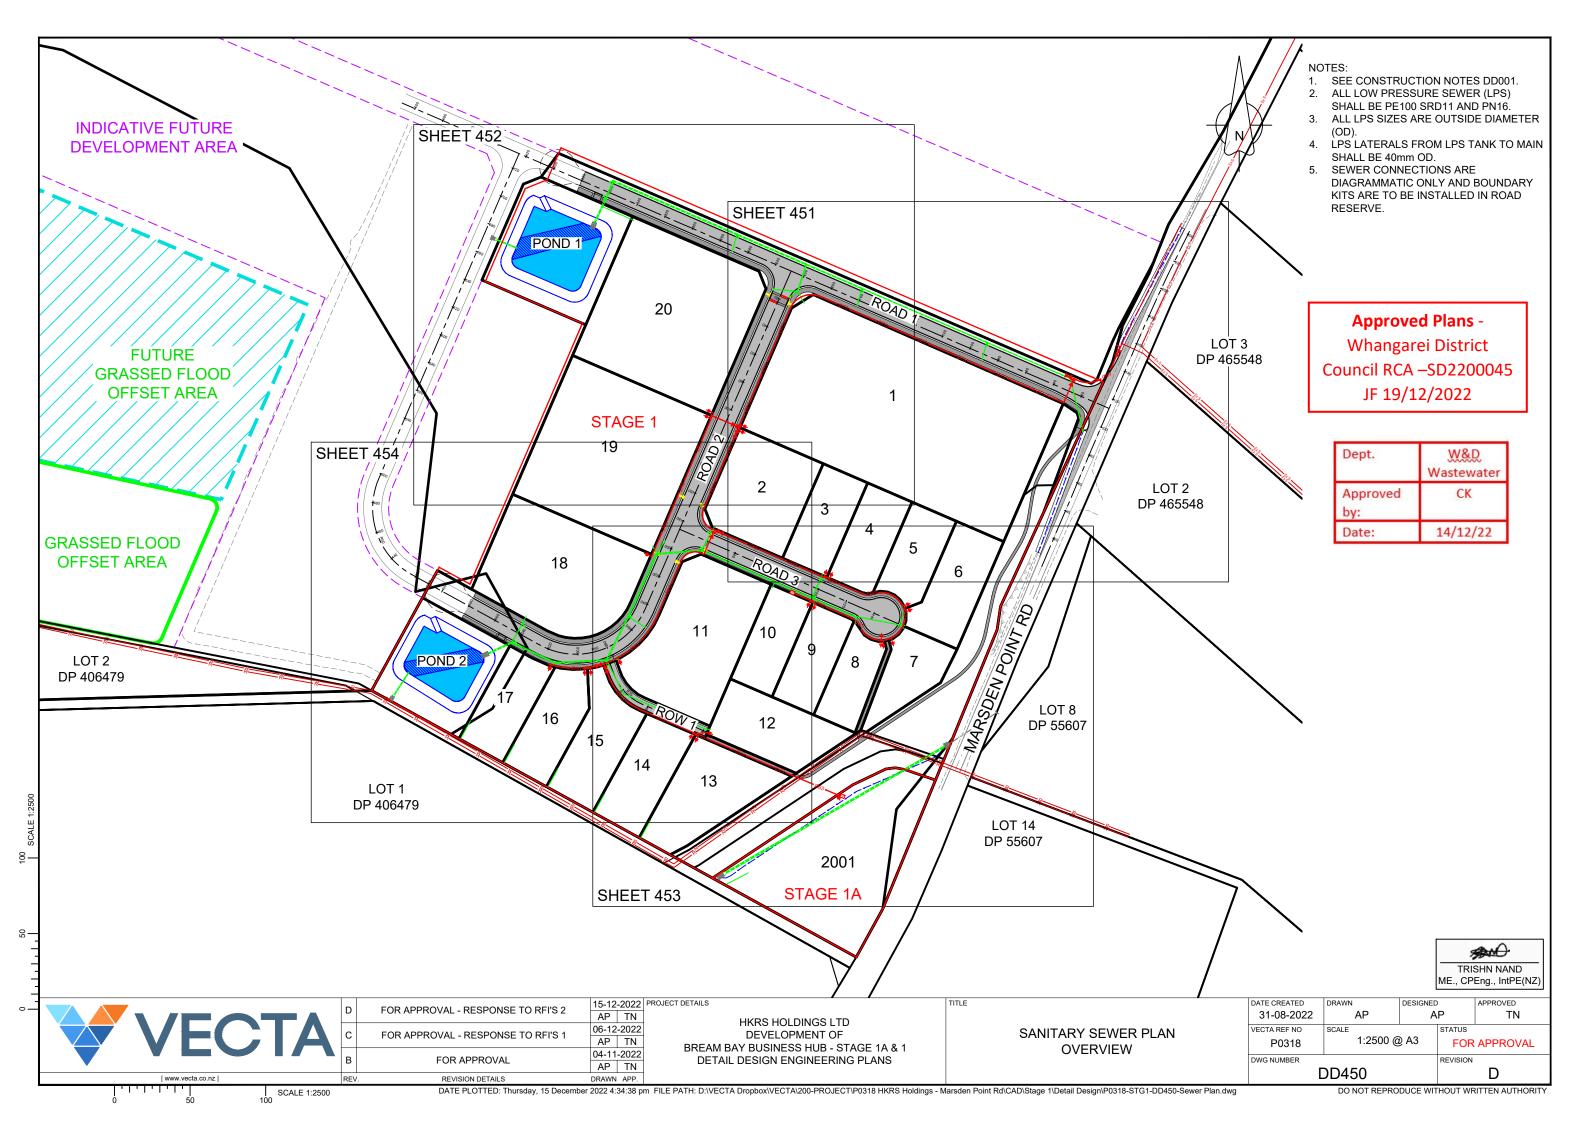


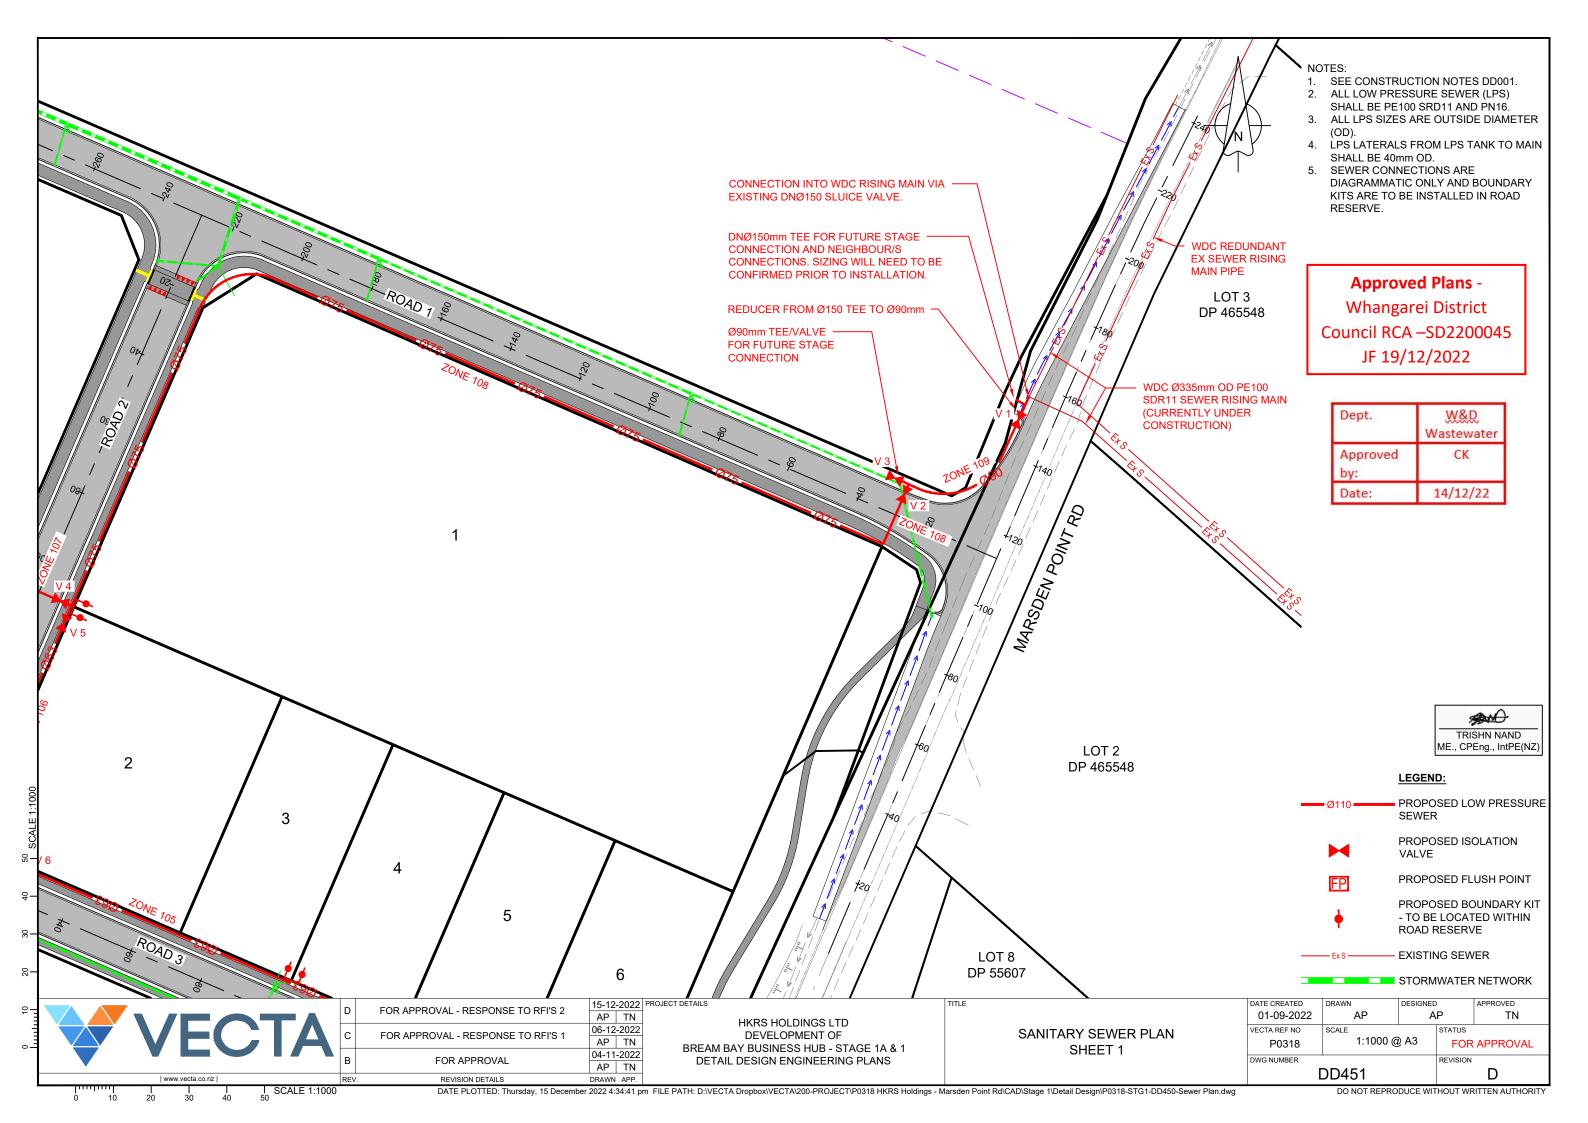


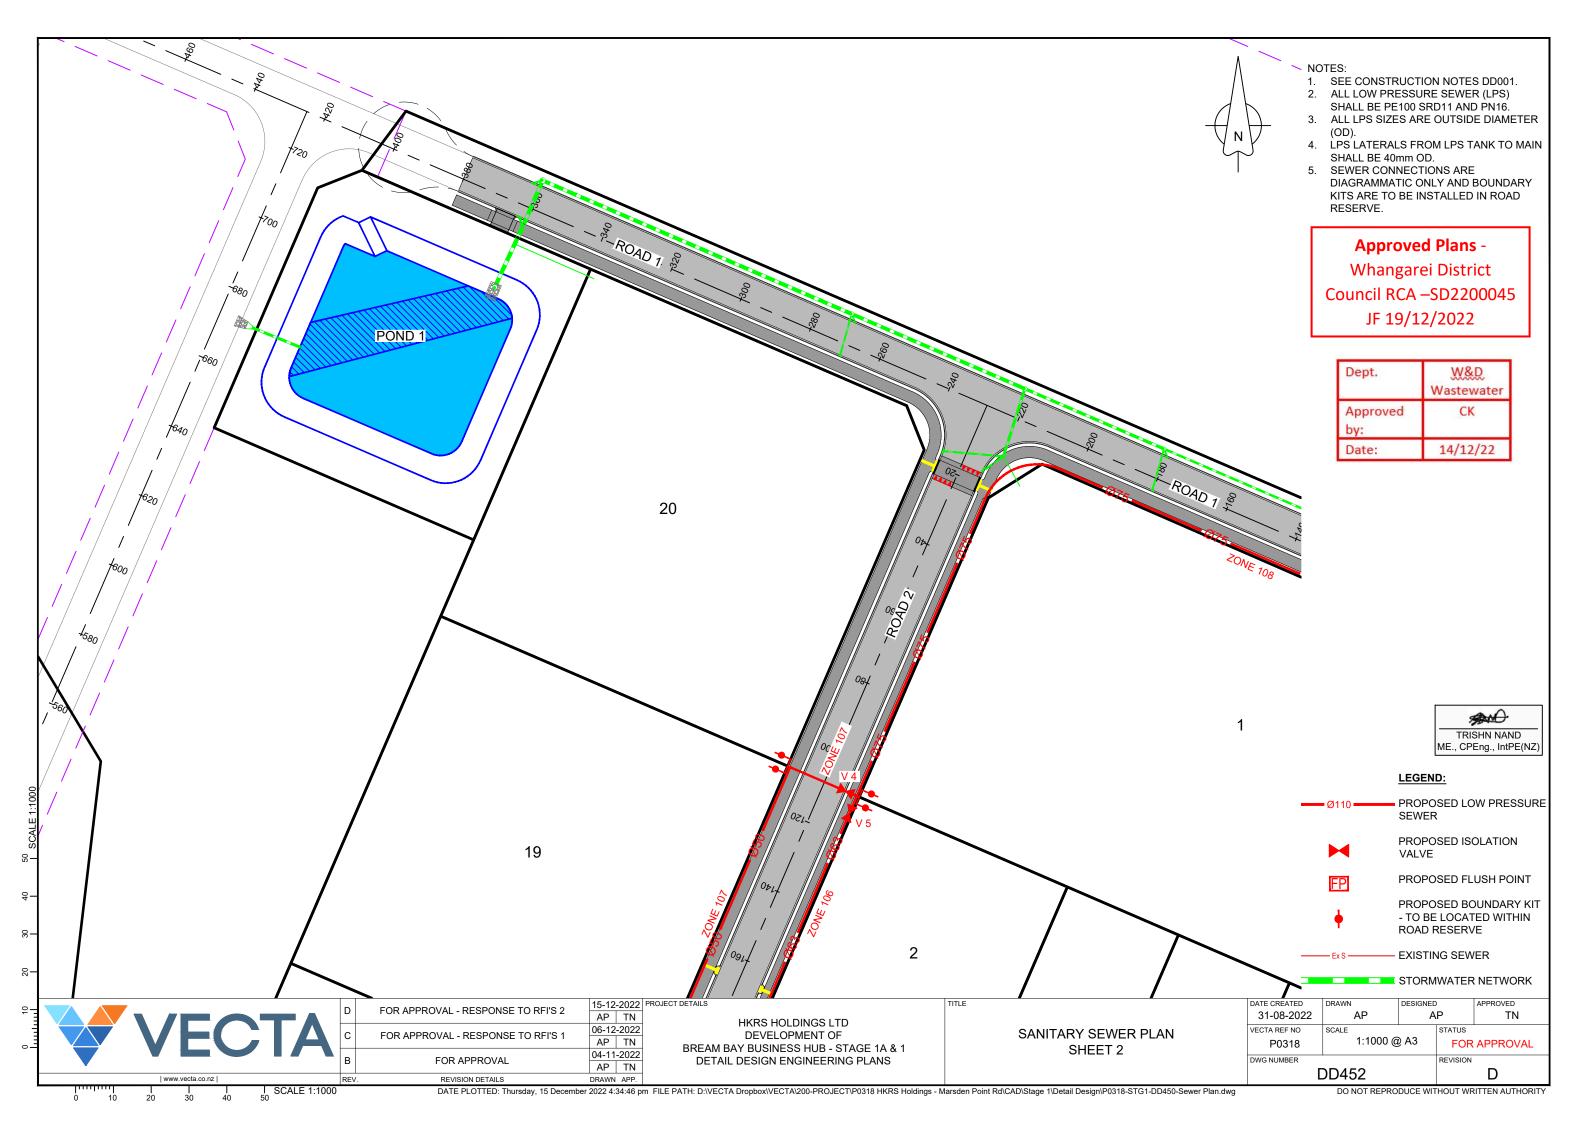

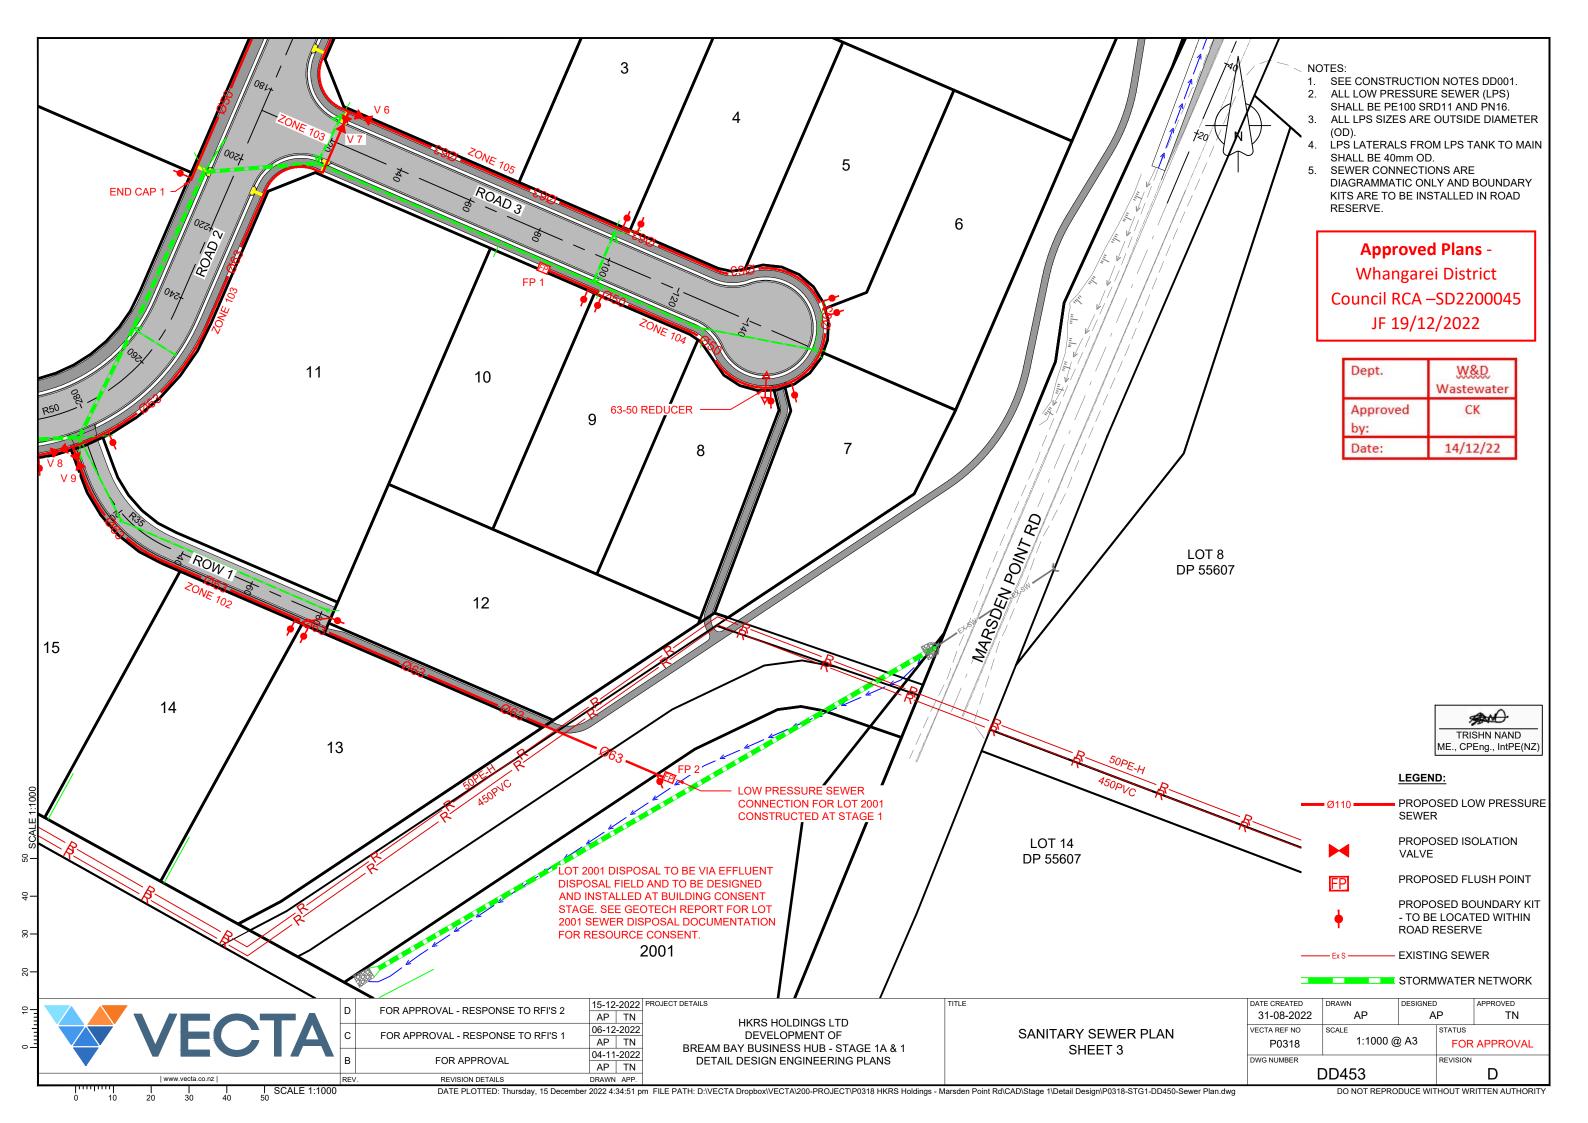

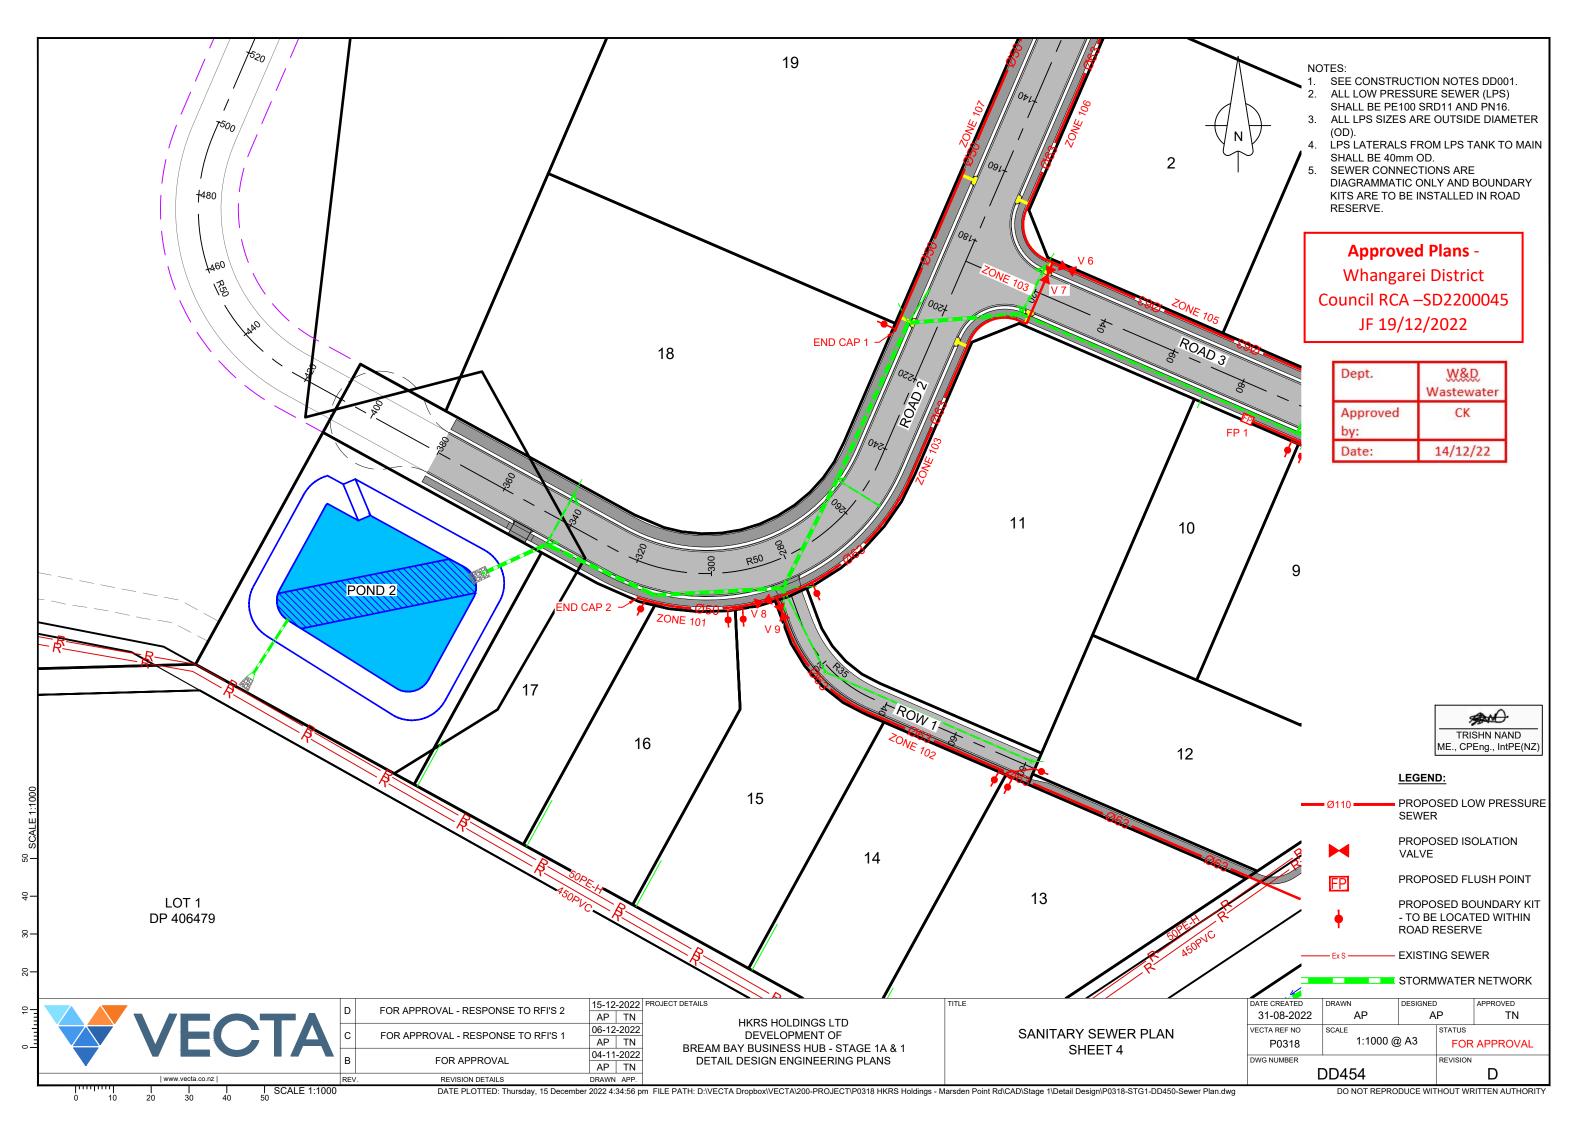

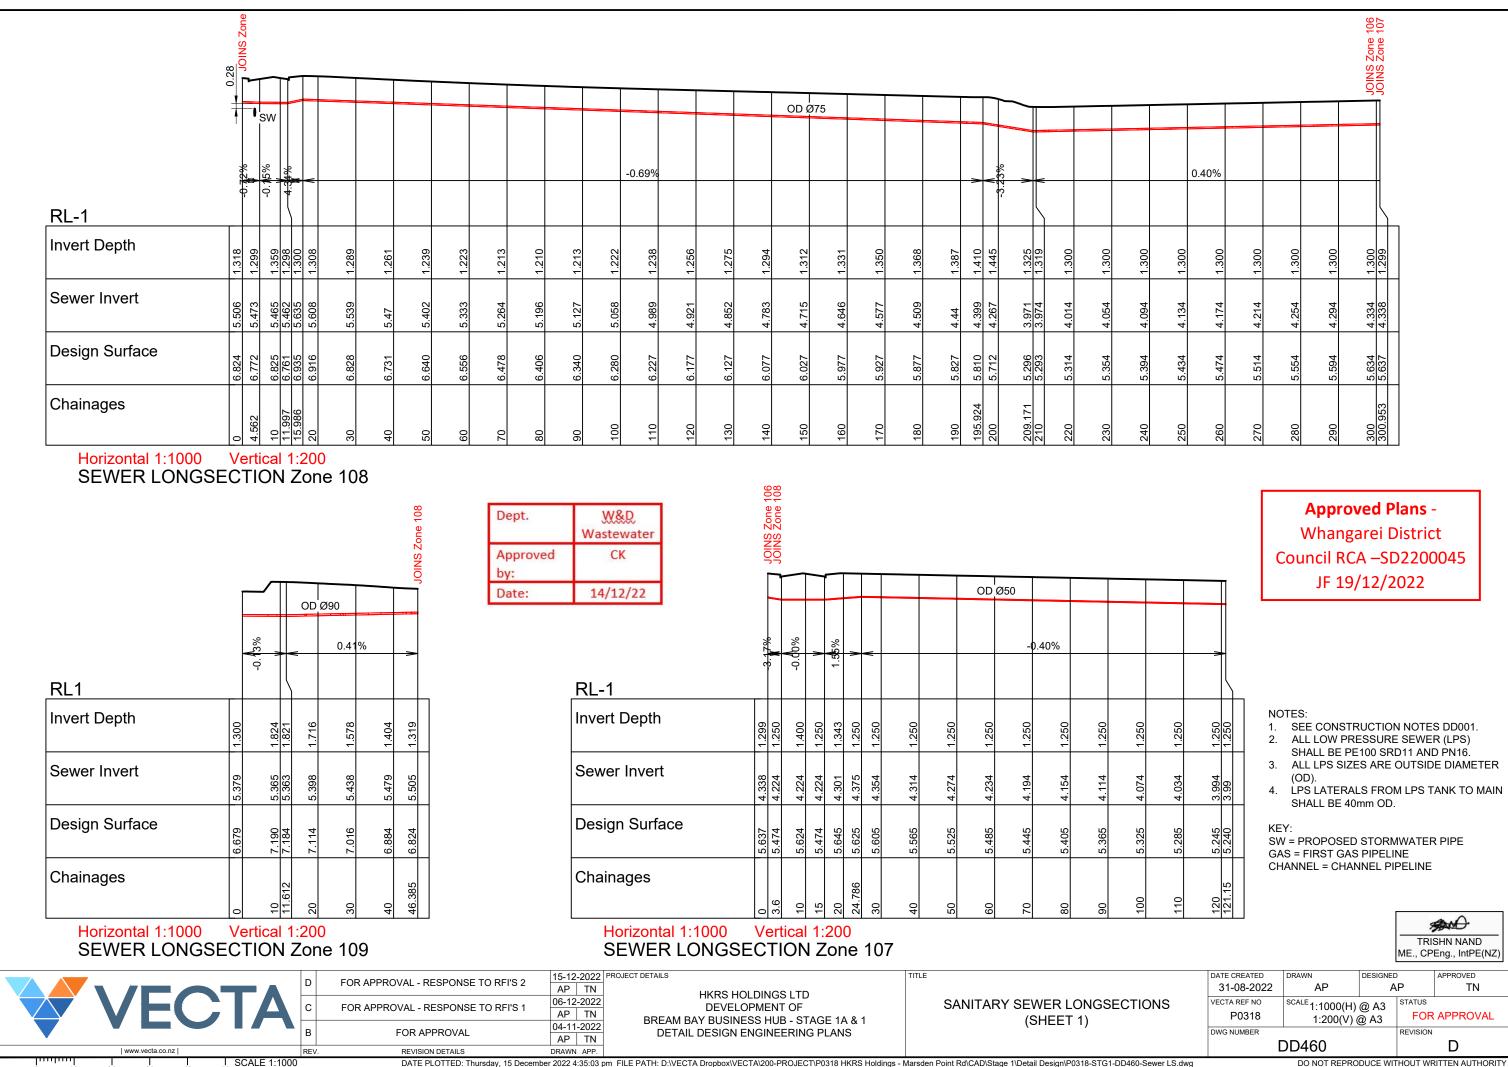

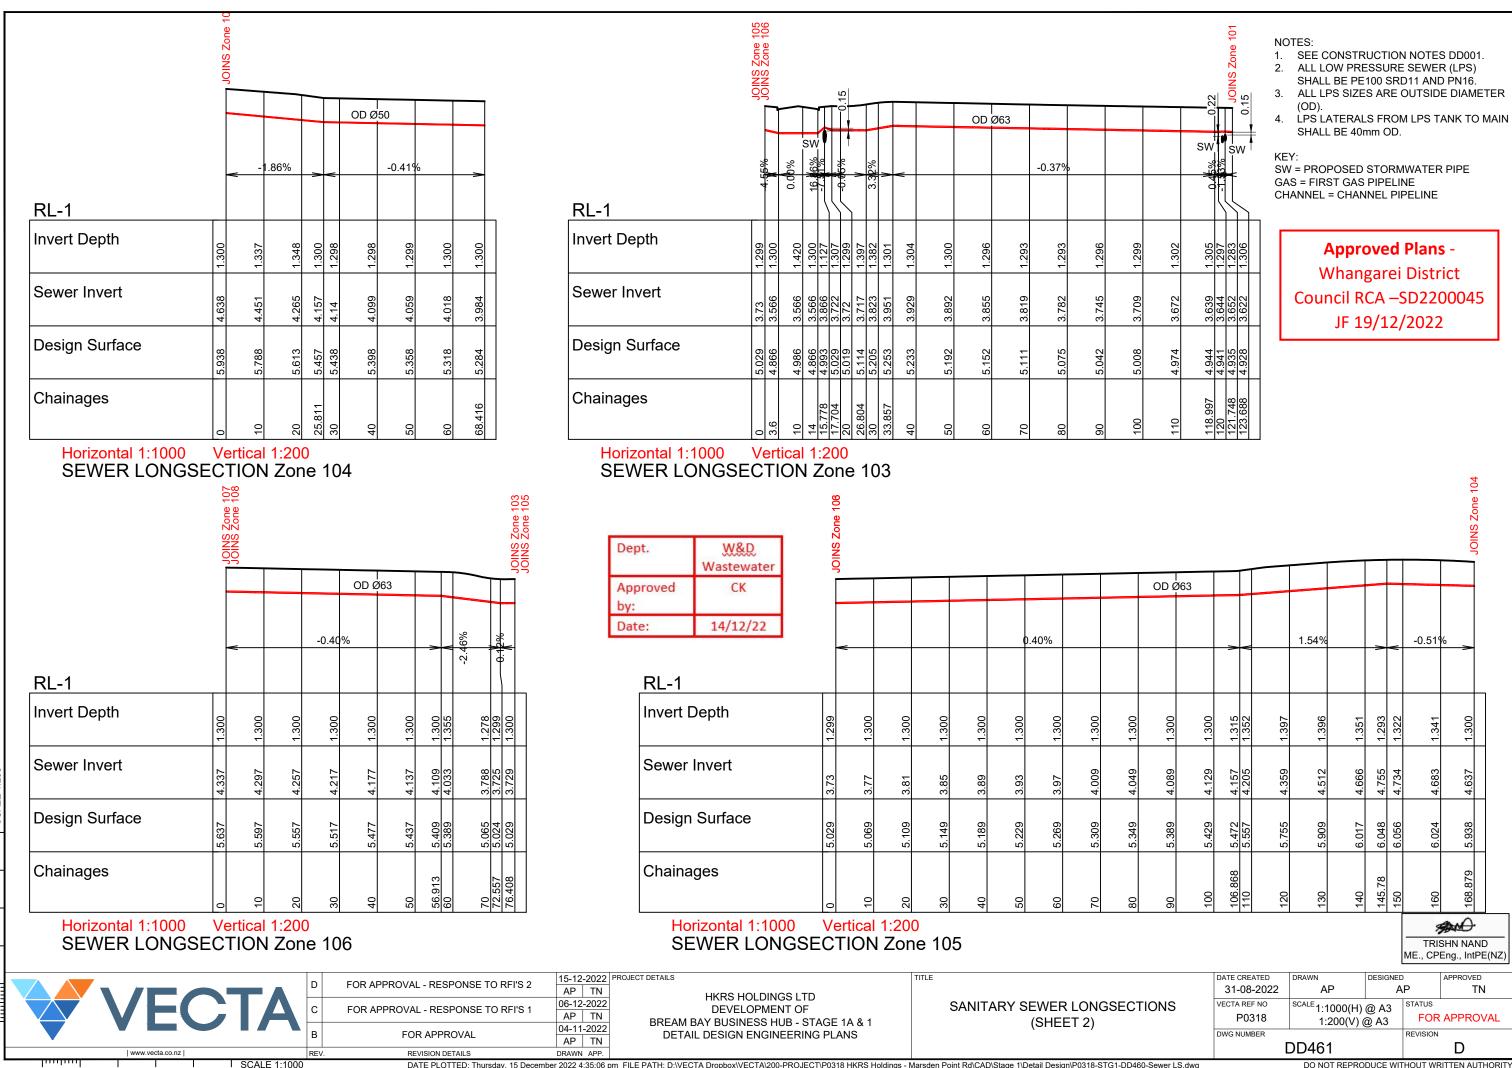

- 1. SEE CONSTRUCTION NOTES DD001.
- 2. ALL LOW PRESSURE SEWER (LPS) SHALL BE PE100 SRD11 AND PN16.
- 3. ALL LPS SIZES ARE OUTSIDE DIAMETER (OD).
- 4. LPS LATERÀLS FROM LPS TANK TO MAIN SHALL BE 40mm OD.

KEY: SW = PROPOSED STORMWATER PIPE

GAS = FIRST GAS PIPELINE CHANNEL = CHANNEL PIPELINE

## **Approved Plans -**

Whangarei District
Council RCA –SD2200045
JF 19/12/2022

Dept.	<u>W&amp;D</u> Wastewater
Approved by:	СК
Date:	14/12/22

RL-1
Invert Depth
Sewer Invert
Design Surface
Chainages

ODINS 2008

ODINS 200

Horizontal 1:1000 Vertical 1:200 SEWER LONGSECTION Zone 101

TRISHN NAND
ME., CPEng., IntPE(NZ)

3.806

5.034

VECTA

RL-3

Invert Depth

Sewer Invert

Design Surface

OD Ø63

0.96%

0.40%


HKRS HOLDINGS LTD DEVELOPMENT OF BREAM BAY BUSINESS HUB - STAGE 1A & 1 DETAIL DESIGN ENGINEERING PLANS

SANITARY SEWER LONGSECTIONS (SHEET 3)

DO NOT REPRODUCE WITHOUT WRITTEN AUTHORITY


GAS

CHANNEL

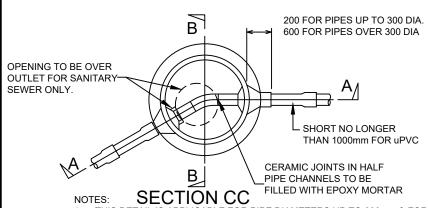

THIS DETAIL IS APPLICABLE FOR PIPE DIAMETERS UP TO 600mm & FOR MANHOLE DEPTHS UP TO 5.0m

- ALL STEEL FITTINGS TO BE HOT DIP GALVANISED ZINC COATINGS TO BE NOT LESS THAN 700g/m
- 150mm THICK REINFORCED CONCRETE LIDS WITH HEAVY DUTY DUCTILE IRON FRAMES & COVERS TO BE USED IN DRIVEWAYS, CARRIAGEWAYS & BERMS. 100mm THICK CONCRETE LIDS WITH LIGHT DUTY CAST IRON FRAMES & COVERS MAY BE USED ELSEWHERE.
- PRECAST MANHOLE BASES SHALL BE USED IN ALL INSTANCES WITH MINIMUM SIZED HOLES CUT FOR PIPE ENTRY.
- NO ADDITIONAL THIN PLASTERING OF BENCHING OR INVERTS IS
- ALL MANHOLE THROATS ARE TO BE PAINTED GREEN FOR STORMWATER, RED FOR SEWER. PAINTING ON MANHOLE COVERS IS OPTIONAL. IF COVERS ARE PAINTED THEY SHALL BE GREEN FOR STORMWATER, RED FOR SEWER WITH 50mm WIDE WHITE STRIP PAINTED THROUGH THE CENTRE OF THE COVER.
- ALL CONCRETE TO BE 20MPa AT 28 DAYS UNLESS SPECIFIED AS WEAK MIX.
- STORMWATER MANHOLES DO NOT REQUIRE HALF PIPE CHANNELS, OR SHORT PIPE SECTIONS BEYOND THE ENTRY OR EXITS.
- STEPPED RUNGS NOT TO BE PROVIDED FOR SEWER MANHOLES.
- 10. BASE TO BE COMPACTED TO RESILIENT MODULUS OF 40MPa FOR ALL PIPES, MANHOLES, SUMPS, PITS, ETC.

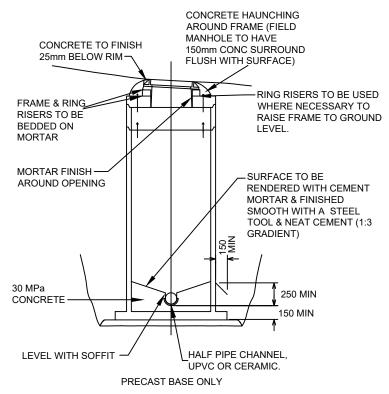

## **SECTION BB**

DUCTILE IRON MANHOLE FRAME & COVER TO BE FLUSH WITH GROUND SURFACE

> GALVANISED TIE BOLTS (MIN 3 PER JOINT)

APPROVED RUBBER/

BITUMEN OR EPOXY

SEALING STRIP (MORTAR

STANDARD 1050DIA

PRECAST MANHOLE

RISER, USE MAXIMUM HEIGHT AVAILABLE TO

MINIMISE NUMBER OF

MAKE WATER-TIGHT JOINT BY

COATING uPVC FOR FULL

SOLVENT CEMENT THEN


EMBEDMENT LENGTH WITH

COATING WET CEMENT WITH

DRY SAND & ALLOWED TO SET.

FINISH BOTH SIDES OF

JOINTS

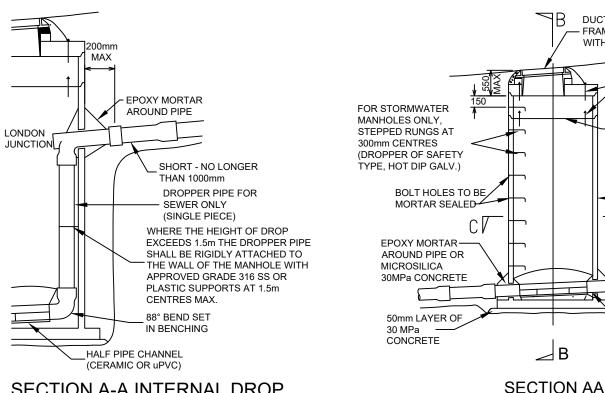


## SECTION A-A INTERNAL DROP

- THIS DETAIL IS APPLICABLE FOR PIPE DIAMETERS UP TO 250mm & FOR MANHOLE DEPTHS UP TO 5.0m & FOR MANHOLE DIAMETERS > 1200mm
- FOR MANHOLE DIAMETERS < 1200mm AN EXTERNAL DROP MUST BE USED (SEE NZS 4404, SHEET CM-004)

## STANDARD PRECAST MANHOLE (SEWER & STORMWATER)

SHEET 37 WDC EES 2010 - NOT TO SCALE

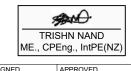

NOTES: 1. SEE CONSTRUCTION NOTES DD001


AP IN  HKRS HOLDINGS LTD  DEVELOPMENT OF  REFAM BAY BUSINESS HUB - STAGE 14 & 1  DRAINAGE TYPICAL DETAILS - SHEET 1  OF AP IN  VECTA REF NO SCALE VECTA REF NO PO318  NTS @ A3 FOR APPROX		n	FOR APPROVAL - RESPONSE TO RFI'S 2	15-12-2022 PROJ	ECT DETAILS	TITLE	DATE CREATED	DRAWN	DESIGNED	APPROVED
C FOR APPROVAL - RESPONSE TO RFI'S 1 DEVELOPMENT OF  RREAM BAY BUSINESS HUB - STAGE 14 & 1			TORALTROVAL TRESI SINGLI TO RITO 2		HKRS HOLDINGS LTD	DDAINAGE TYPICAL DETAILS CHEET 1	31-08-2022	AP	AP	TN
AP TN RREAM BAY BUSINESS HUB - STAGE 14 & 1	,		EOD ADDDOVAL DESDONSE TO DEI'S 1	06-12-2022		DRAINAGE I YPICAL DETAILS - SHEET T	VECTA REF NO			TATUS
		VELLA	TON AFFINOVAL - NESFONSE TO NITS T	AP TN			P0318	NTS (	@ A3	FOR APPROVAL
B FOR APPROVAL DETAIL DESIGN ENGINEERING PLANS TYPICAL MANHOLE DETAILS DWG NUMBER REVISION			FOR APPROVAL	04-11-2022		TYPICAL MANHOLE DETAILS	DWG NUMBER		RE	EVISION
DD470 D	<u> </u>		1 011711 1110 1712	AP TN	BETT HE BESTOTT ENGINEER WITCH ENGINE			DD470		D
www.vecta.co.nz   REV. REVISION DETAILS DRAWN APP.	<u>.                                    </u>	www.vecta.co.nz   RE\	V. REVISION DETAILS	DRAWN APP.				DD470		U


**Approved Plans -**


Whangarei District

Council RCA -SD2200045

JF 19/12/2022

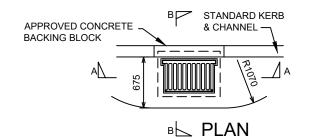

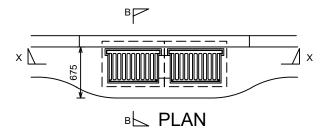

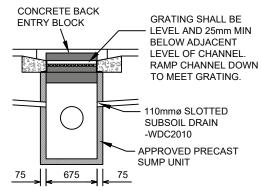


#### SUMP GRATINGS TO GRATING SHALL BE AT A MIN. BE LEVEL (WHERE OF 25mm BELOW ADJACENT PRACTICABLE) CONCRETE LEVEL OF CHANNEL. RAMP BACK-ENTRY CHANNEL DOWN TO MEET BLOCKS GRATING. 110ø SLOTTED SUBSOIL DRAIN 300g CORE HOLE **BETWEEN SUMPS** 375ø OUTLET APPROVED PRECAST-675 SUMP UNITS 75 **SECTION X-X DOUBLE SUMP**

SHEET 34 WDC EES 2010 - NOT TO SCALE

#### SECTION A-A SINGLE SUMP SHEET 34 WDC EES 2010 - NOT TO SCALE

- CATCHPIT NOTES:

  1. CONCRETE TO BE ORDINARY GRADE
  (20MPa) IN ACCORDANCE WITH NZS 3109.
- 2. SUMP OUTLET PIPES TO BE 1:100 MIN
- GRADIENT.
  3. GRATES TO BE CYCLE FRIENDLY AND TO BE PLACED OUTSIDE KERB RAMP/PRAM

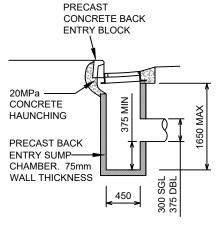

**SECTION B-B** 

**Approved Plans** - Whangarei District

Council RCA -SD2200045

JF 19/12/2022




**BEVEL FOR INLETS** 

450 - 600 633 MESH OR D10 RODS AT 250 CRS 675 - 900 D12 RODS AT 250 CRS 1050 - 1350 D12 RODS AT 150 CRS

SECTION

SHEET 35 WDC EES 2010 - NOT TO SCALE

- ALL REINFORCEMENT SHALL BE PLACED CENTRALLY IN WALLS AND FLOOR, AND SHALL BE CONTINUOUS BETWEEN WALLS AND FLOOR.
- 3. LAPS IN STRUCTURAL GRADE BARS TO BE 300 MIN.

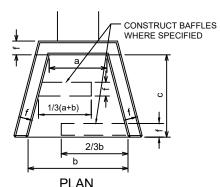

SHEET 35 WDC EES 2010 - NOT TO SCALE

**END ELEVATION** 


SHEET 35 WDC EES 2010 - NOT TO SCALE

12 DIA TRIMMER ROD


1 IN 12 FALL

20mm CHAMFER

ALL CORNERS

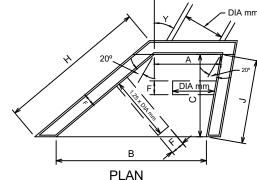

SHEET 35 WDC EES 2010 - NOT TO SCALE

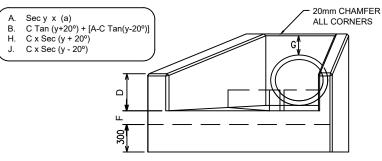

END ELEVATION

SHEET 35 WDC EES 2010 - NOT TO SCALE

PRINCIPAL DIMENSIONS (mm)							
DIA OF PIPE	DIA OF a		b c d e C D E		f F	g G	
150	300	450	600	200	325	100	150
230	380	600	700	250	425	100	150
300	450	750	750	300	525	100	150
375	550	900	850	350	625	100	150
450	630	1100	900	400	725	150	230
525	700	1200	1000	450	825	150	230
600	800	1400	1100	550	900	150	230
750	1000	1700	1200	600	1050	150	300
900	1170	2000	1450	650	1225	150	300
1050	1380	2300	1700	750	1375	150	300
1200	1520	2600	2100	750	1550	150	450
1350	1680	2800	2400	750	1725	150	450

- 4. THERE SHALL BE A LEAST 2 BARS WHETHER MESH OR M.S. OVER THE TOP OF THE PIPE.
- CONCRETE IS TO BE ORDINARY GRADE (17.5MPa) IN ACCORDANCE WITH NZS 3109.
- BAFFLES ARE TO BE CONSTRUCTED AS SHOWN WHEN OUTLET VELOCITIES AND SOIL CONDITIONS DICTATE, IN EXTREME CASES SPECIFIC DESIGN MAY BE REQUIRED BY THE COUNCIL.
- 7. INLET STRUCTURES SHALL HAVE REVERSE APRON FALL AND NO BAFFLES.

## INLET AND OUTFALL STRUCTURES

1/2 D OR

MAX 400mm

#### NOTES:

- 1. SEE CONSTRUCTION NOTES DD001.
- ALL INLET AND OUTLET HEADWALL STRUCTURES TO BE FITTED WITH THE RELEVANT HYNDS WINGWALL GRILLE FOR ALL HEADWALLS >Ø375.



VECTA D FOR AF


HKRS HOLDINGS LTD
DEVELOPMENT OF
BREAM BAY BUSINESS HUB - STAGE 1A & 1
DETAIL DESIGN ENGINEERING PLANS

DRAINAGE TYPICAL DETAILS - SHEET 2


TYPICAL SUMP & HEADWALL DETAILS

		ı			
DATE CREATED	DRAWN	DESIGNED	)	APPROVED	
31-08-2022	AP	A	.P	TN	
VECTA REF NO	SCALE		STATUS		
P0318	NTS @	A3	FOR APPROVAL		
DWG NUMBER			REVISION		
		D			

#### REINSTATE TO PREVIOUS SURFACE (WHERE PRACTICABLE)

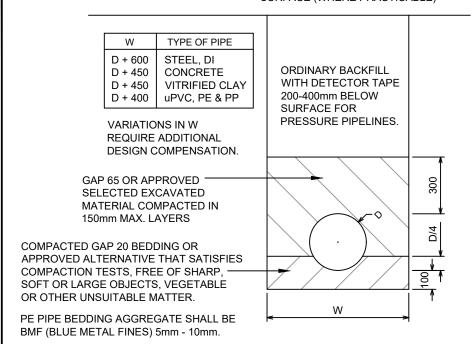


#### REINSTATE TO PREVIOUS SURFACE (WHERE PRACTICABLE)

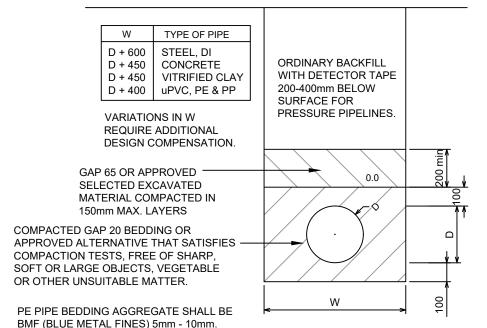

## CONCRETE, DUCTILE IRON, STEEL OR VITRIFIED CLAY PIPE

SHEET 31 WDC EES 2010 - NOT TO SCALE (WHERE SPECIFICALLY APPROVED)

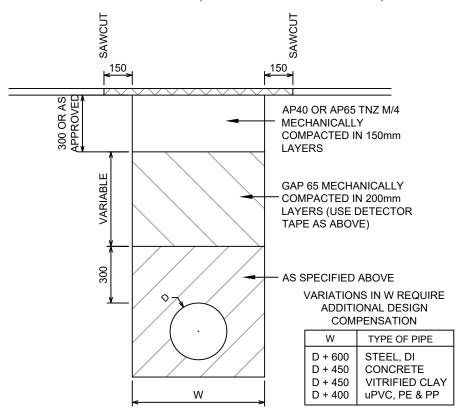

ADDITIONAL BACKFILL REQUIREMENTS
UNDER CARRIAGEWAYS

(ALL TYPES OF PIPE)

NOT TO SCALE

## PVC, PE & PP PIPE

SHEET 31 WDC EES 2010 - NOT TO SCALE (PVC & PP NOT APPROVED FOR WATER SUPPLY)

#### NOTES

- CONCRETE PIPES TO BE RCRRJ TO AS/NZS 4058 INSTALLED TO MANUFACTURERS' REQUIREMENTS.
- ORDINARY BACKFILL SHALL BE FREE FROM STONES OR ROCKS GREATER THAN 150mm NOMINAL DIAMETER COMPACTED IN 300mm LAYERS.
- 3. REPLACE TOPSOIL TO ORIGINAL DEPTH AS NECESSARY
- 4. EXISTING SEALED ROADWAY EXCAVATIONS ARE TO BE RESURFACED WITH 50mm OF ASPHALTIC CONCRETE.
- 5. CLEGG HAMMER TEST:
  - 0-300mm DEPTH RANGE CLEGG READING NOT LESS THAN 45. 300mm-1.5m DEPTH RANGE CLEGG READING NOT LESS THAN 30. 1.5m-TOP OF PIPE BEDDING MATERIAL CLEGG READING NOT LESS THAN 25.
- 6. PRIVATEWAY BASE COURSE METALLING WITHIN PIPE TRENCHES MAY BE IN ACCORDANCE WITH THE PRIVATEWAY STANDARDS.
- 7. TRENCH WIDTH SHALL NOT EXCEED W AT THE PIPE CROWN LEVEL.
- 8. UNSATISFACTORY TRENCH MATERIAL IS TO BE UNDERCUT AND REPLACED WITH COMPACTED HARDFILL. IN POOR SOILS SUCH AS SWAMP, PEAT, AND IN ROCK THE MINIMUM DEPTH OF GRANULAR BEDDING MATERIAL BELOW THE INVERT IS TO BE 200mm OR SPECIFIC DESIGN AS NECESSARY.
- 9. PIPELINES AT 1:8 GRADIENT OR STEEPER SHALL HAVE CEMENT STABILISED BEDDING AND/OR SURROUNDS.
- PIPELINES AT 1:3 GRADIENT OR STEEPER SHALL HAVE WEAK MIX CONCRETE BEDDING (10MPa) IN ACCORDANCE WITH SHEET 32. LARGE PIPES WILL REQUIRE SPECIFIC PIER DESIGN.
- CONCRETE BEDDING SHALL BE ALLOWED TO CURE FOR 48 HOURS PRIOR TO BACKFILLING.
- BACKFILLING CARRIAGEWAYS MAY BE WITH 'FLOWABLE FILL' (LOW STRENGTH FLY-ASH CONCRETE).
- 13. GRANULAR BEDDING IS TO SATISFY N.Z.S. 7643 APPENDIX B.
- 14. MINIMUM COVER OVER PIPES (UNLESS SPECIFICALLY DESIGNED OR PROTECTED IN ACCORDANCE WITH SHEET 32).
- 14.A. 600mm IF NOT SUBJECTED TO TRAFFIC LOADING
- 14.B. 900mm UNDER CARRIAGEWAYS AND TRAFFICKED AREAS.
- 15. SAND IS NOT PERMITTED AS PE PIPE BEDDING.


PROJECT DETAILS

## Approved Plans -

Whangarei District
Council RCA –SD2200045
JF 19/12/2022

#### NOTES:

1. SEE CONSTRUCTION NOTES DD001.

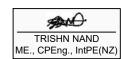

# VECTA

	D	FOR APPROVAL - RESPONSE TO RFI'S 2	15-12-2022			
	ט	FOR APPROVAL - RESPONSE TO RF13 2	AP	TN		
	C	FOR APPROVAL - RESPONSE TO RFI'S 1	06-12-2022			
	C	FOR APPROVAL - RESPONSE TO KETS T	AP	TN		
	В	FOR APPROVAL	04-11-2022			
	Ь	FOR APPROVAL		TN		

HKRS HOLDINGS LTD
DEVELOPMENT OF
BREAM BAY BUSINESS HUB - STAGE 1A & 1
DETAIL DESIGN ENGINEERING PLANS

DRAINAGE TYPICAL DETAILS - SHEET 3

TYPICAL PIPE BEDDING DETAILS

 DATE CREATED
 DRAWN
 DESIGNED
 APPROVED


 31-08-2022
 AP
 AP
 TN

 VECTA REF NO<br/>P0318
 SCALE<br/>NTS @ A3
 STATUS<br/>FOR APPROVAL

 DWG NUMBER
 REVISION

 DD472
 D

Approved Plans -Whangarei District Council RCA –SD2200045 JF 19/12/2022

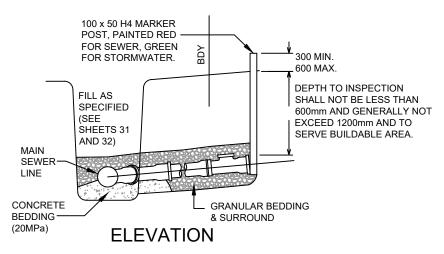

## MARKING OF SS & SW CONNs

CONNECTIONS SHALL BE SEALED WITH REMOVABLE CAPS UNTIL REQUIRED. THE CAPS ARE TO BE PAINTED:

RED FOR SEWER WITH 'SS' PAINTED/FIXED ONTO THE END CAP.


 $\underline{\mathsf{GREEN}}$  FOR STORMWATER WITH 'SW' PAINTED/FIXED ONTO THE END CAP.

POSITIONS ARE ALSO TO BE MARKED WITH A WOODEN STAKE (MIN 100x50) EXTENDING FROM THE INVERT OF THE CONNECTION TO 600mm ABOVE GROUND LEVEL. STAKES ARE TO BE PAINTED:

RED FOR SEWER WITH 'SS' PAINTED/FIXED ONTO THE


 $\underline{\mathsf{GREEN}} \ \mathsf{FOR} \ \mathsf{STORMWATER} \ \mathsf{WITH} \ \mathsf{'SW'} \qquad \mathsf{PAINTED/FIXED} \ \mathsf{ONTO} \ \mathsf{THE} \ \mathsf{END} \ \mathsf{CAP}.$ 

100 x 50 H4 MARKER

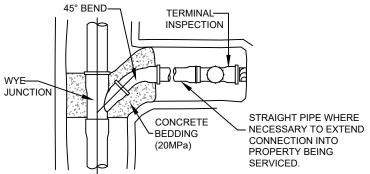


#### NOTES

- THE TERMINAL INSPECTION SHALL BE LOCATED NOT LESS THAN 300mm INSIDE THE PROPERTY BEING SERVICED AND BE FREE OF OBSTRUCTIONS.
- 2. FOR STORMWATER CONNECTIONS, JUNCTIONS TO BE (IN ORDER OF PREFERENCE):
  - a. PREFABRICATED STANDARD WYE JUNCTIONS
  - b. PREFABRICATED FACTORY SPECIAL CONNECTION, EPOXY MORTARED SADDLED FLANGE CONNECTION WITH APPROPRIATE INSERT ADAPTOR >DN 225.
- TERMINAL BLANK END REQUIRED FOR STORMWATER CONNECTIONS.
- 4. PIPES AND FITTINGS ARE TO BE SEWER GRADE uPVC, OR CONCRETE TO RELEVANT NZ STANDARD.
- PIPELINES THAT ARE LIKELY TO CARRY COMMERCIAL OR INDUSTRIAL WASTE ARE TO SATISFY THE MANUFACTURER'S REQUIREMENTS.
- SPECIFIC DESIGN MAY BE REQUIRED IN POTENTIALLY UNSTABLE AREAS.
- JOINT FLEXIBILITY IS TO BE MAINTAINED WHERE PIPELINES ARE IN CONTACT WITH CONCRETE. PIPES SHALL BE SEPARATED FROM CONCRETE USING DPC.
- 8. AS-BUILT PLANS ARE REQUIRED FOR ALL CONNECTIONS.

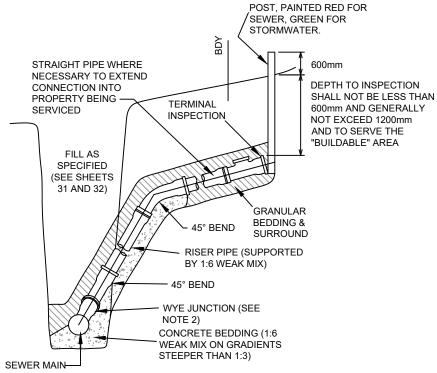

#### RAMPED RISER CONNECTION

SHEET 36 WDC EES 2010 - NOT TO SCALE (REQUIRES SPECIFIC APPROVAL)

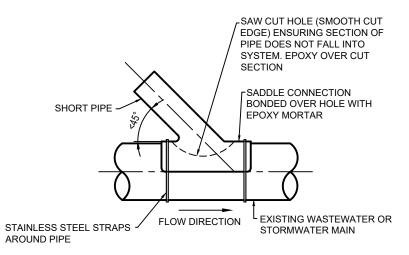


## SADDLE CONNECTION

IF MAIN > 225mm

OTES:

SEE CONSTRUCTION NOTES DD001.

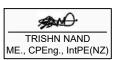




D	FOR APPROVAL - RESPONSE TO RFI'S 2	15-12	-2022	PROJECT DETAILS
ט	FOR AFPROVAL - RESPONSE TO RF13 2	AP	TN	
С	FOR APPROVAL - RESPONSE TO RFI'S 1	06-12	-2022	
	FOR APPROVAL - RESPONSE TO KFIS T	AP	TN	BRFA
В	FOR APPROVAL	04-11	-2022	DF.
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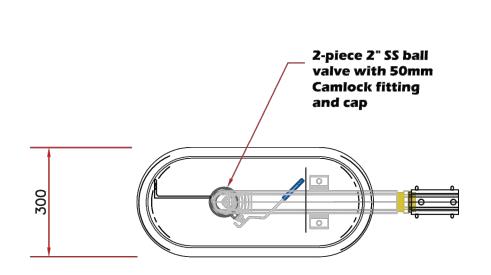
HKRS HOLDINGS LTD
DEVELOPMENT OF
BREAM BAY BUSINESS HUB - STAGE 1A & 1
DETAIL DESIGN ENGINEERING PLANS

DRAINAGE TYPICAL DETAILS - SHEET 4

TYPICAL STORMWATER CONNECTION DETAILS

DATE CREATED	DRAWN	DESIGNED	)	APPROVED		
31-08-2022	AP	A	.P	TN		
VECTA REF NO	SCALE	•	STATUS			
P0318	NTS @	A3	FOR APPROVAL			
DWG NUMBER			REVISION			
		D				




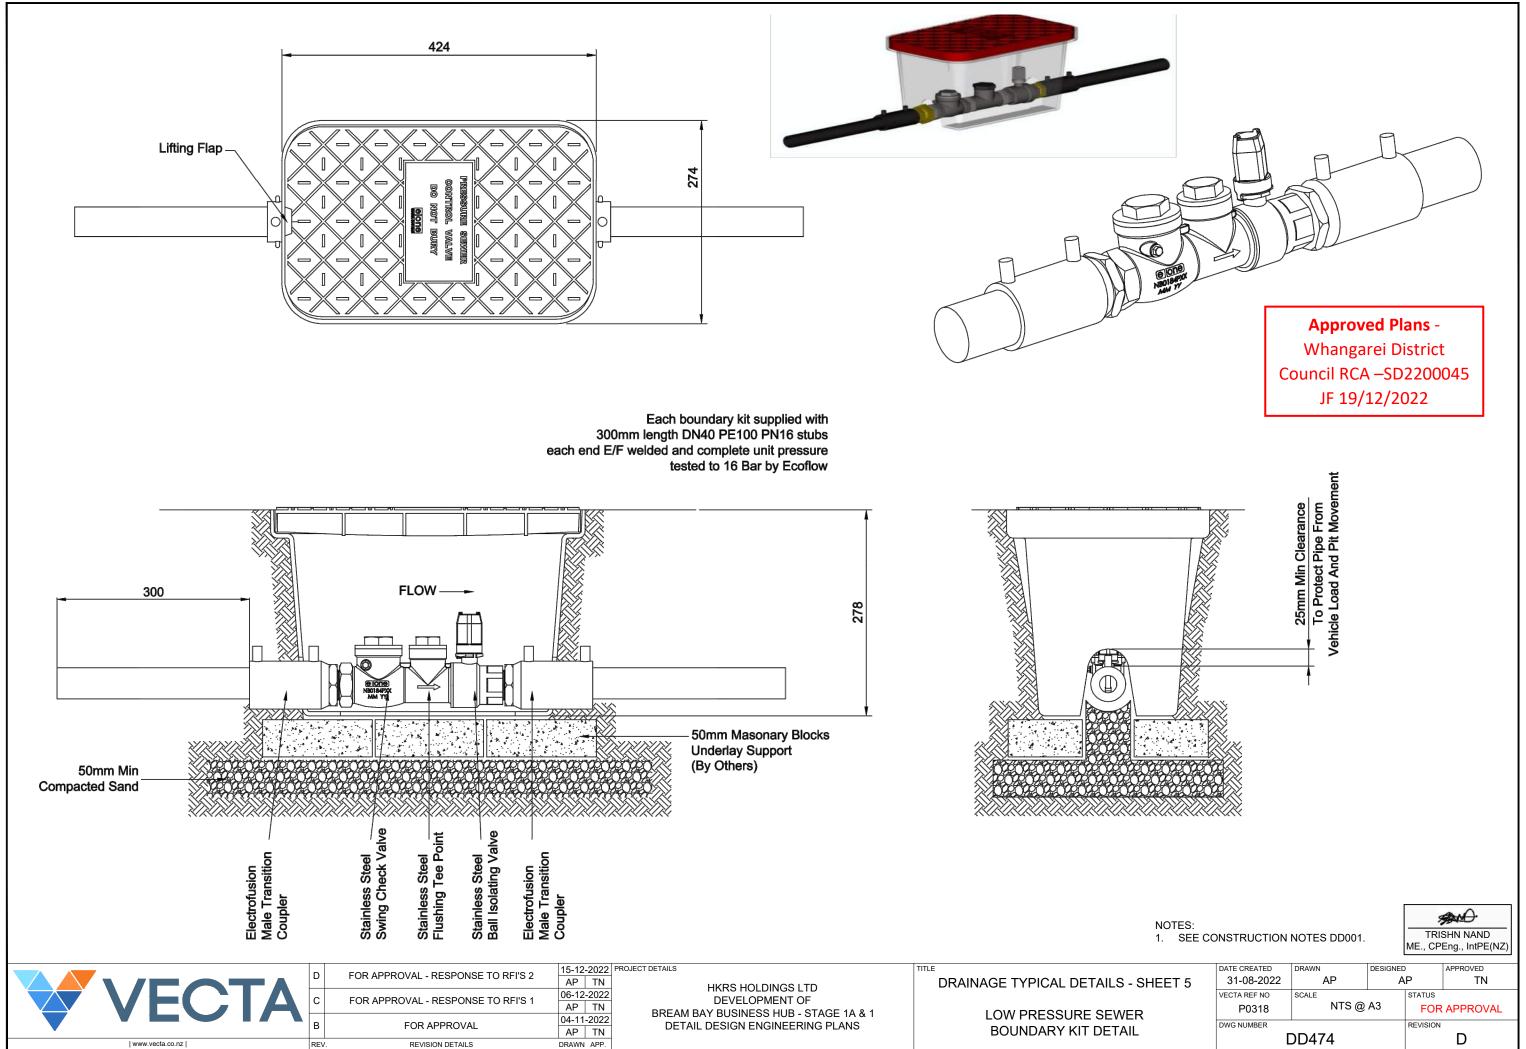


Approved Plans -Whangarei District Council RCA –SD2200045 JF 19/12/2022



## **Plan View**

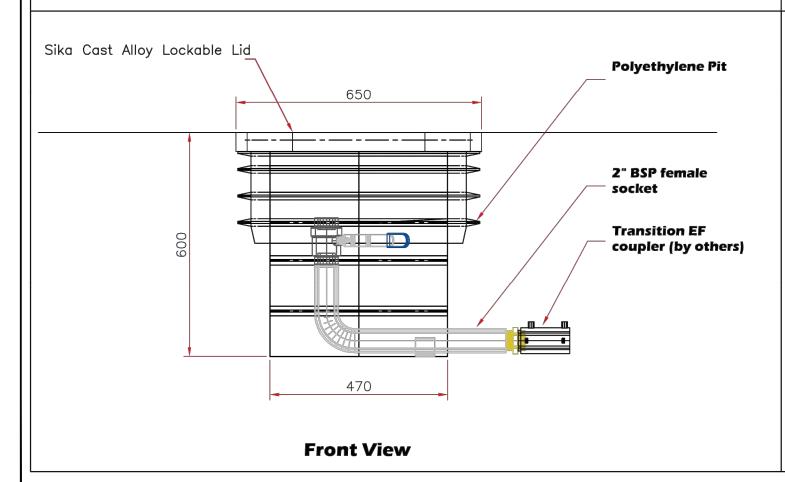

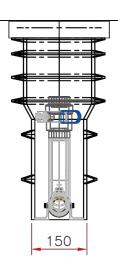

NOTES:

1. SEE CONSTRUCTION NOTES DD001.

**Side View** 

TRISHN NAND ME., CPEng., IntPE(NZ)




_	FOR APPROVAL - RESPONSE TO RFI'S 2	15-12	-2022	PROJECT DETAILS
	FOR APPROVAL - RESPONSE TO RF13 2	AP	TN	
$\overline{}$	FOR APPROVAL - RESPONSE TO RFI'S 1	06-12	-2022	
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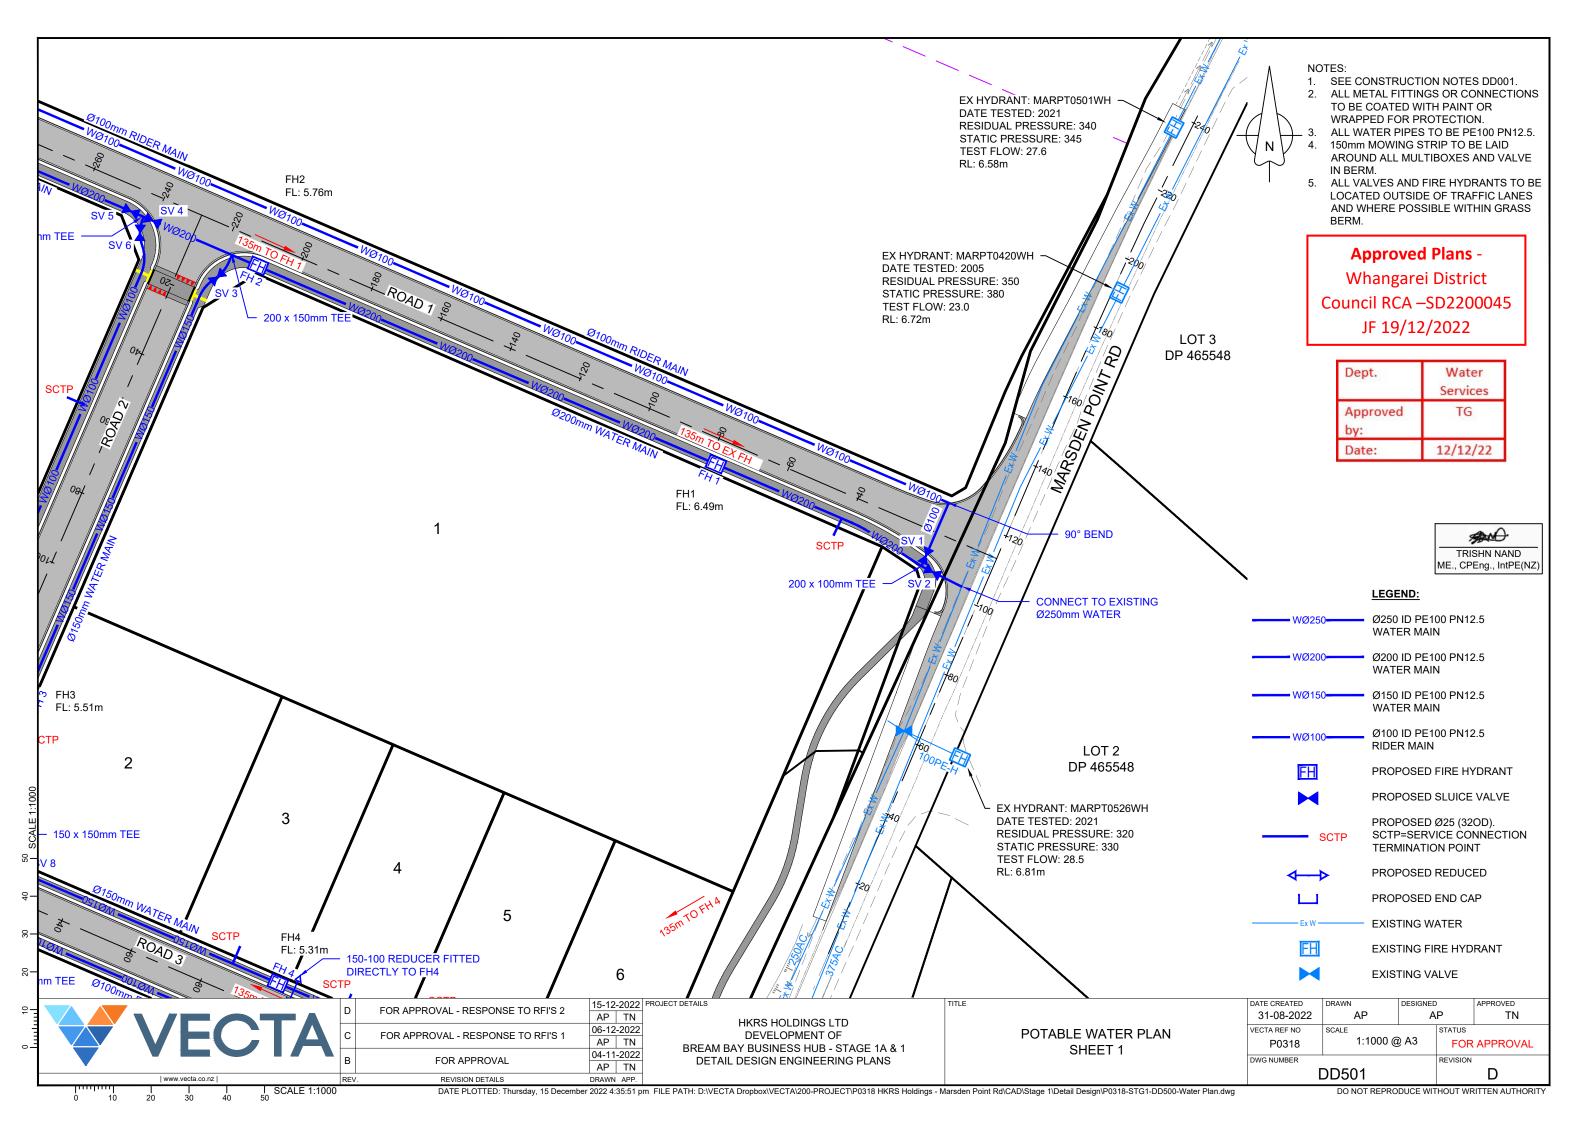
HKRS HOLDINGS LTD
DEVELOPMENT OF
BREAM BAY BUSINESS HUB - STAGE 1A & 1
DETAIL DESIGN ENGINEERING PLANS


DRAINAGE TYPICAL DETAILS - SHEET 6


LOW PRESSURE SEWER FLUSHING POINT DETAIL


DATE CREATED	DRAWN	DESIGNED	)	APPROVED		
31-08-2022	AP	A	.P	TN		
VECTA REF NO	SCALE		STATUS			
P0318	NTS @	A3	FOR APPROVAL			
DWG NUMBER		REVISION				
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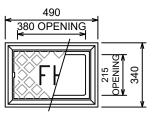





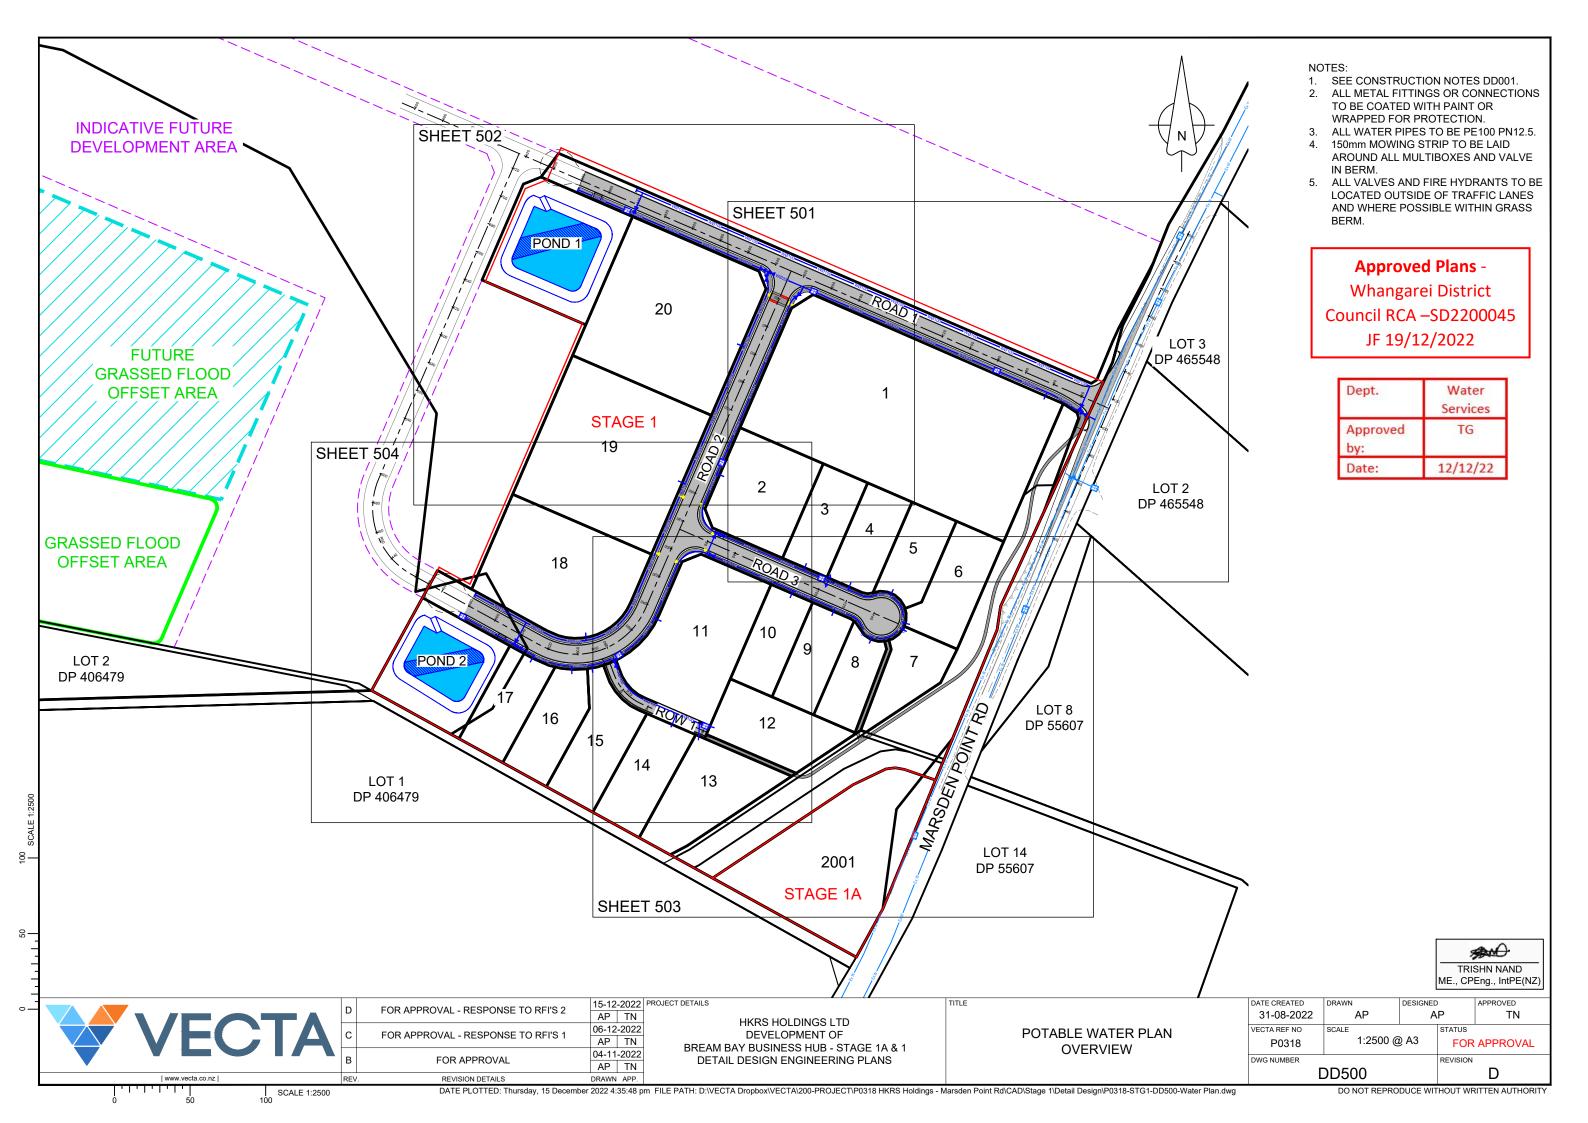

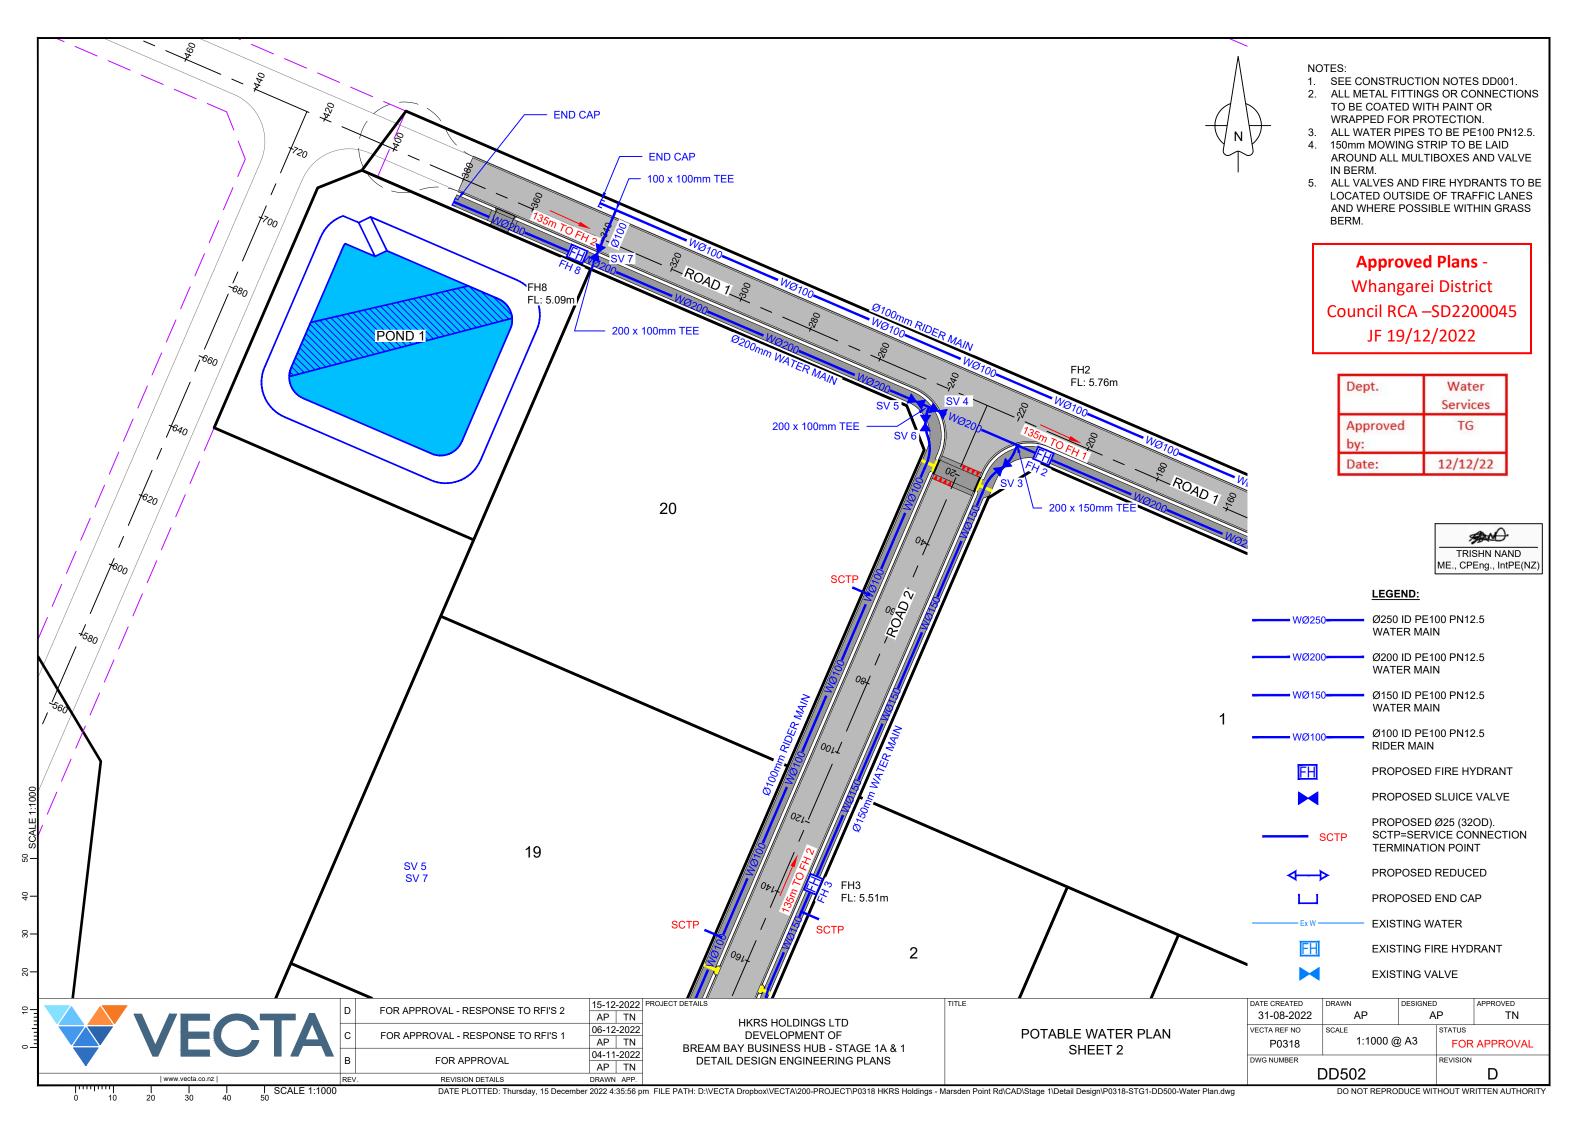

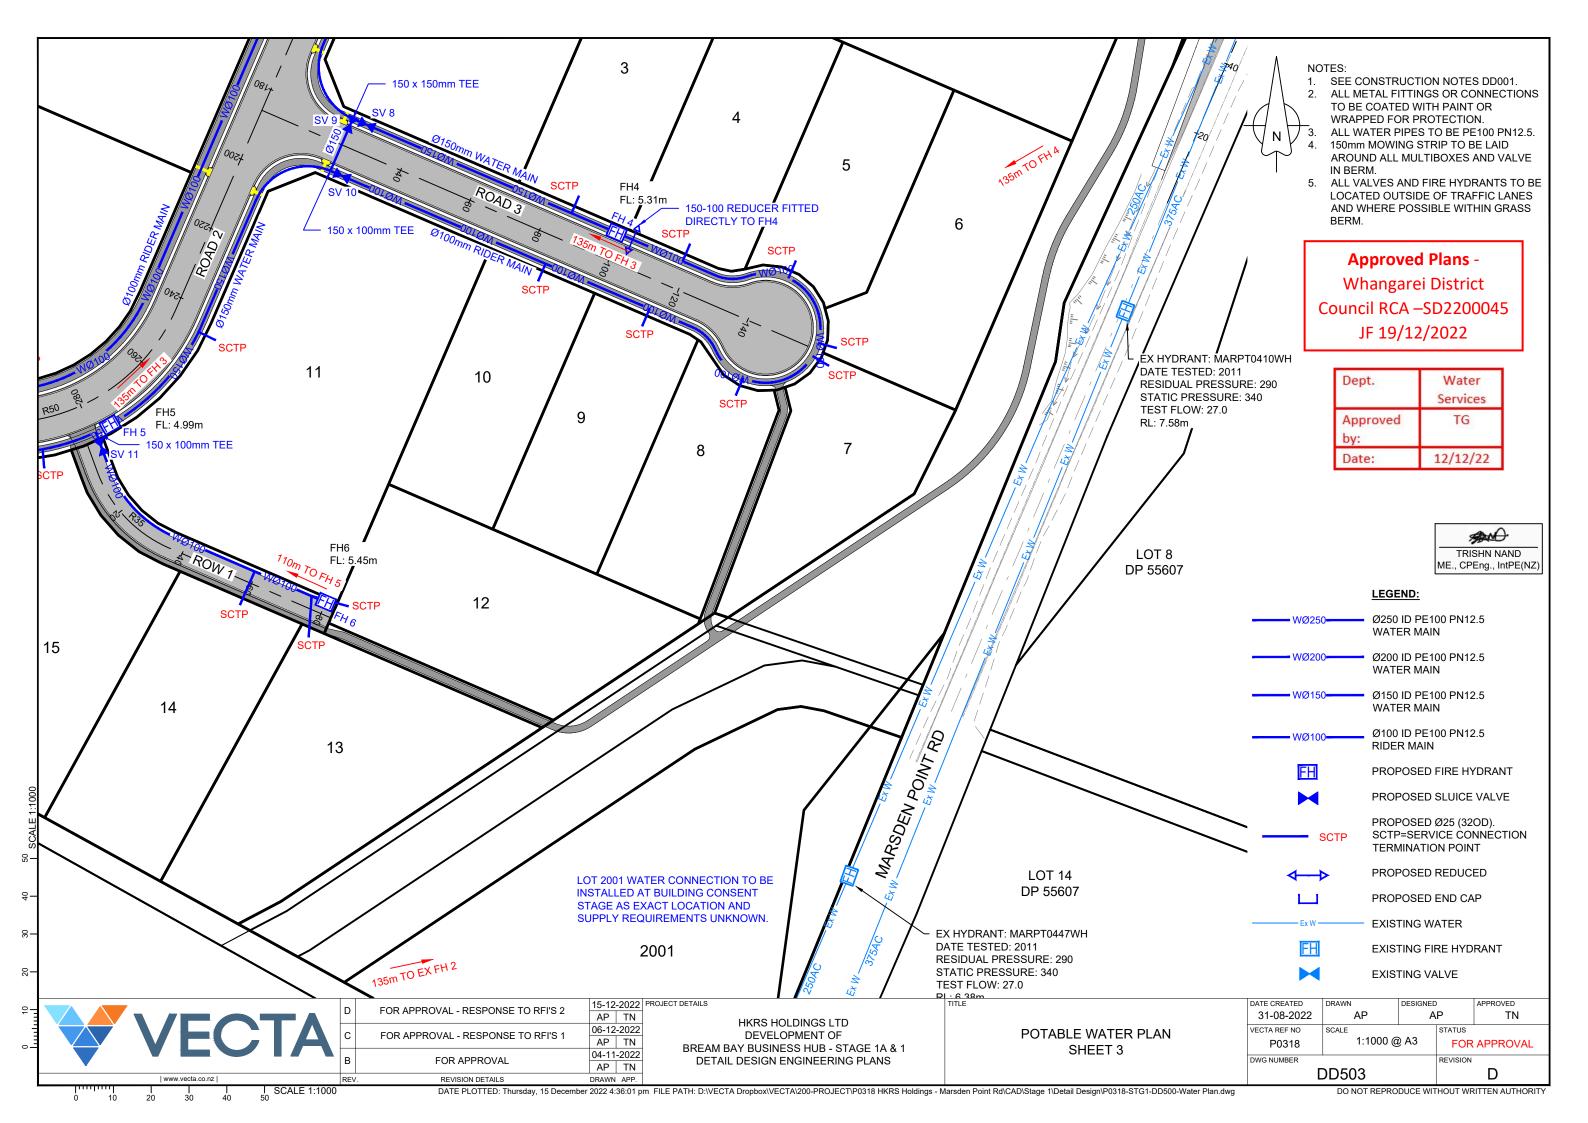"TALL TYPE" SCREW DOWN DI HYDRANT TO NZS 4522:2010. TO CLOSE CLOCKWISE WHEN VIEWED FROM ABOVE.

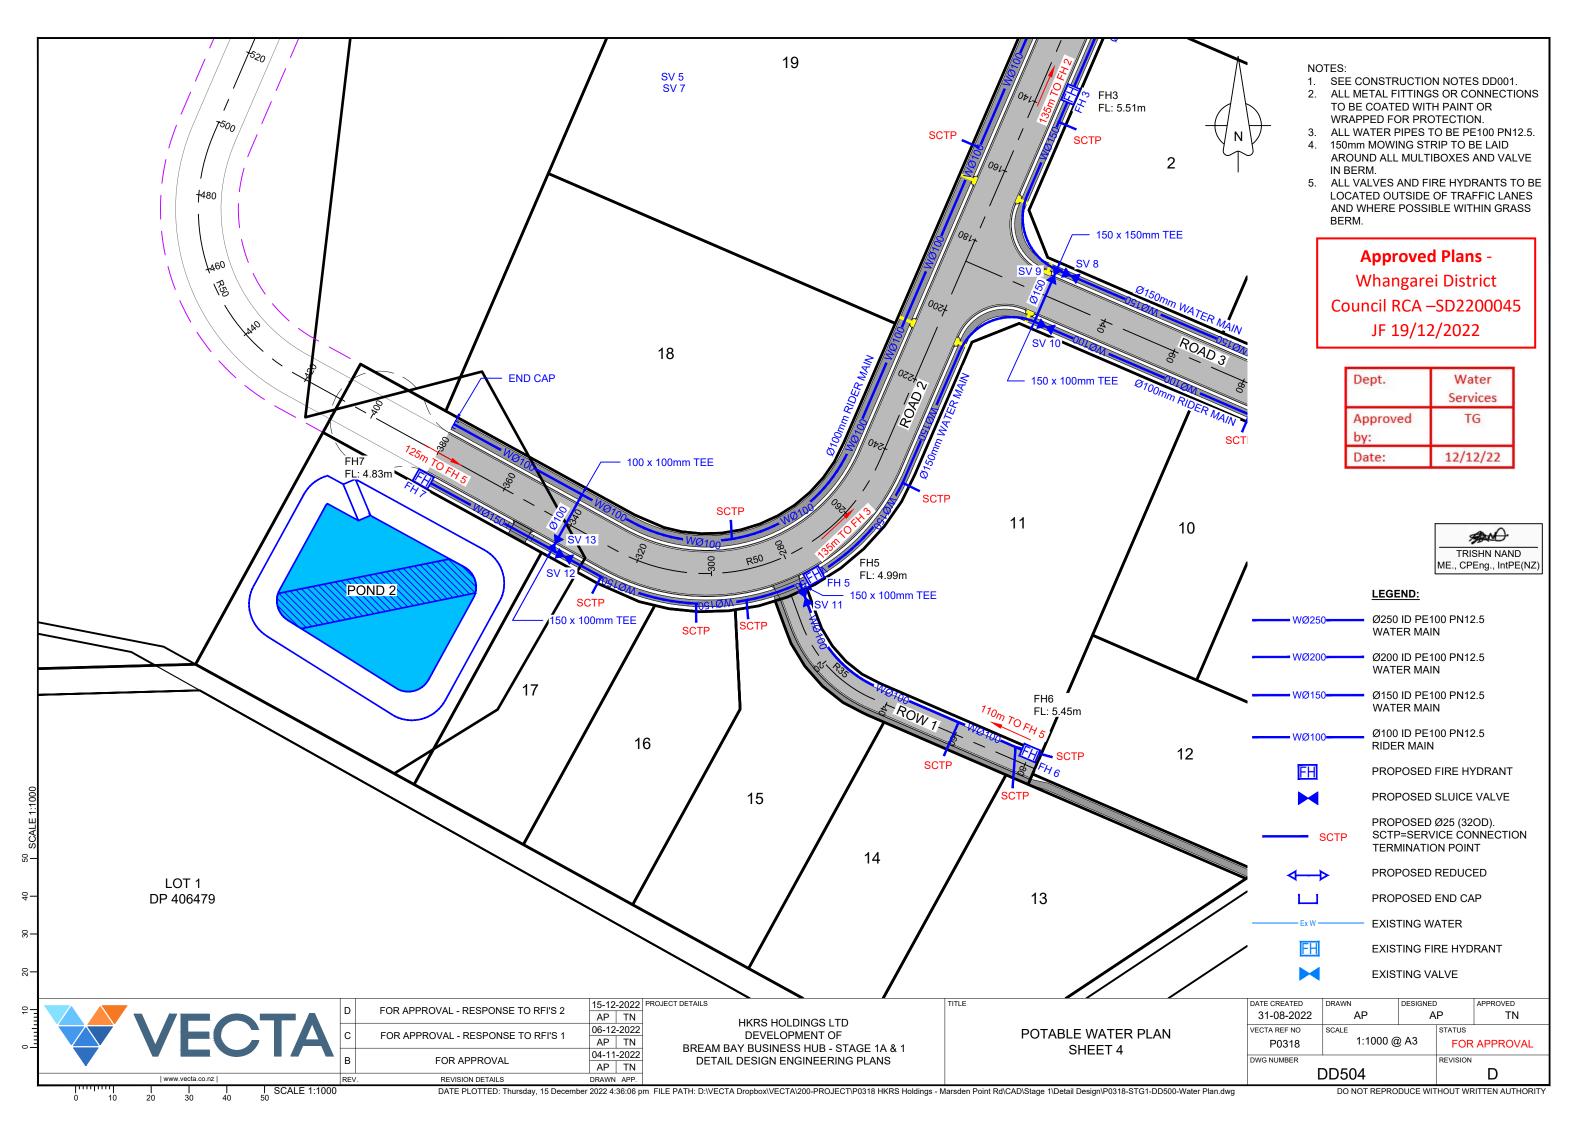


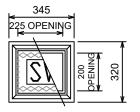



## CAST IRON HYDRANT BOX

### **CAST IRON VALVE BOX**

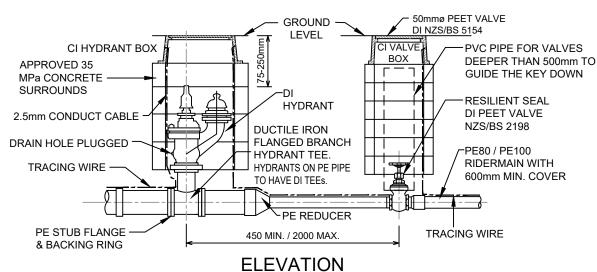



#### NOTES

- DEFLECTION OF JOINTS IS NOT TO EXCEED THE MANUFACTURER'S RECOMMENDATION.
- WHERE THERE ARE MORE THAN 15 CONNECTIONS FROM A RIDER MAIN, AN ISOLATING PEET VALVE SHOULD BE PROVIDED IN THE MIDDLE OF THE RIDER MAIN.
- ALL UNDERGROUND BOLTS TO BE STAINLESS STEEL AND WRAPPED WITH DENSO TAPE, MASTIC AND POLYTAPE.
- SERVICE CONNECTIONS TO TERMINATE JUST OUTSIDE FRONT BOUNDARY WITH AN APPROVED MANIFOLD, METER BOX (INCLUDING BASE) AND DIAPHRAGM VALVE INCLUDING DUAL CHECK VALVE.
- DIMENSIONS TO BE SUPPLIED WITH AS-BUILTS.

## FH & VALVE INSTALLATION DETAILS

SHEET 45 WDC EES 2010 - NOT TO SCALE

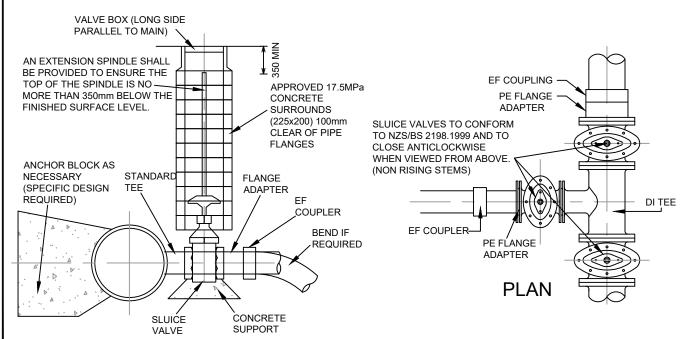

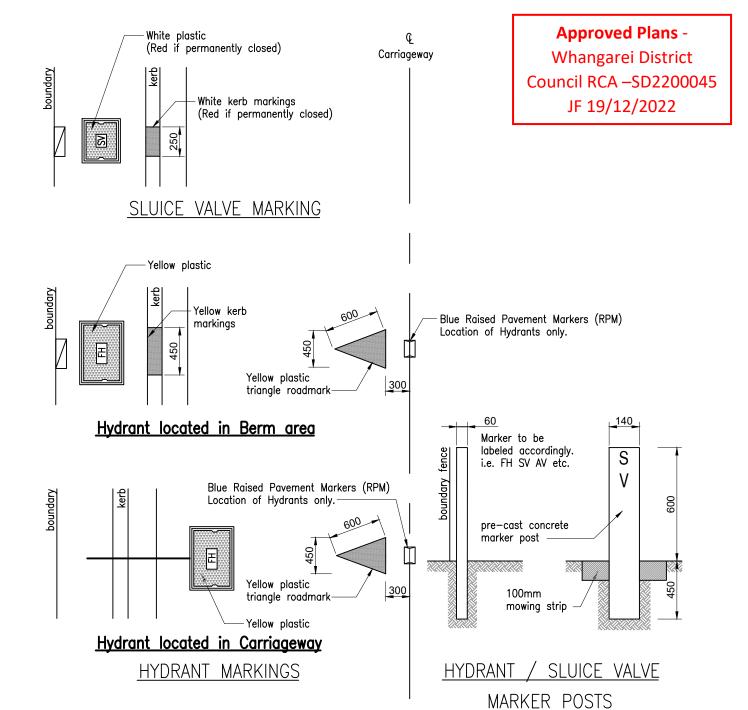


Pre-cast concrete marker post to be painted white for valves and yellow for hydrants.

## **VALVE INSTALLATION DETAILS**

SHEET 49 WDC EES 2010 - NOT TO SCALE

NOTES: 1. SEE CONSTRUCTION NOTES DD001

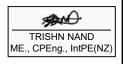



**ELEVATION** 


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U	FOR AFFROVAL - RESPONSE TO RETS 2	AP	TN
D	FOR APPROVAL - RESPONSE TO RFI'S 2	15-12	-2022
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HKRS HOLDINGS LTD DEVELOPMENT OF BREAM BAY BUSINESS HUB - STAGE 1A & 1 DETAIL DESIGN ENGINEERING PLANS

PROJECT DETAILS

POTABLE WATER TYPICAL DETAILS SHEET 1

DATE CREATED DRAWN DESIG		DESIGNED	)	APPROVED		
31-08-2022	AP	A	P	TN		
VECTA REF NO	SCALE		STATUS			
P0318	NTS @	A3	FOR APPROVAL			
DWG NUMBER			REVISION			
		D				

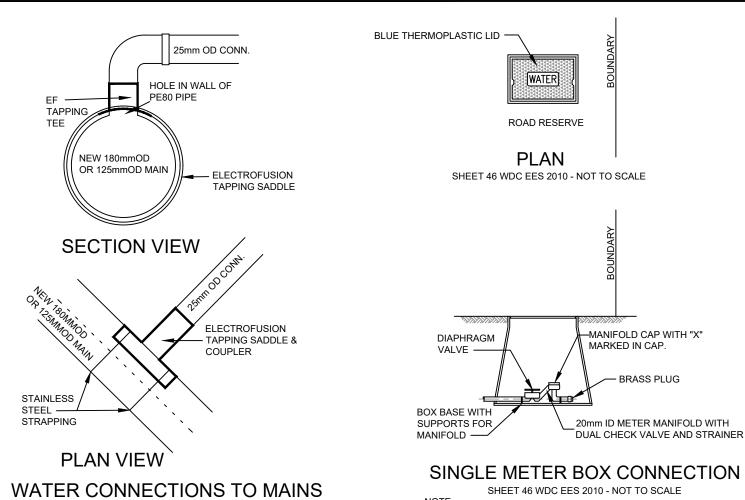


SHEET 46 WDC EES 2010 - NOT TO SCALE

- ALL FITTINGS TO BE WDC APPROVED
- BACKFLOW PREVENTERS SHALL BE PROVIDED IF REQUIRED BY WDC BYLAWS AND SHALL BE INSTALLED IN A SEPARATE BOX.

GENERAL:

NOT TO SCALE

- WEAK MIX CONCRETE: 1 PART CEMENT TO 6 PARTS AGGREGATE.
- CEMENT STABILISED BEDDING AND BACK FILL: 1 PART CEMENT TO 20 PARTS AGGREGATE.
- ALLOW 48 HOURS CURING PRIOR TO BACK FILLING ANY CONCRETE OR STABILISED MATERIAL.

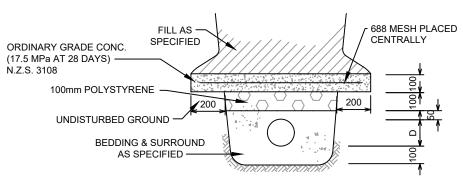

## REINFORCED CONCRETE SLAB **PROTECTION**

FOR WATER PIPELINES THAT HAVE LESS THAN 600mm COVER AND ARE NOT UNDER CONCRETE ROADS OR DRIVEWAYS (NOT TO SCALE)

NOTES: 1. SEE CONSTRUCTION NOTES DD001.

9 TRISHN NAND ME., CPEng., IntPE(NZ)

15-12-2022 PROJECT DETAILS FOR APPROVAL - RESPONSE TO RFI'S 2 AP TN 06-12-2022 FOR APPROVAL - RESPONSE TO RFI'S AP TN 04-11-2022 FOR APPROVAL REVISION DETAILS

HKRS HOLDINGS LTD DEVELOPMENT OF BREAM BAY BUSINESS HUB - STAGE 1A & 1 DETAIL DESIGN ENGINEERING PLANS

POTABLE WATER TYPICAL DETAILS SHEET 2

31-08-2022 TN VECTA REF NO NTS @ A3 P0318 FOR APPROVAL DD511


DO NOT REPRODUCE WITHOUT WRITTEN AUTHORITY

**Approved Plans -**

Whangarei District

Council RCA -SD2200045 JF 19/12/2022

#### NOTES: THIS SURVEY HAS BEEN COMPLETED UNDER INSTRUCTION BY THE CLIENT FOR ITS INTENDED PURPOSE. THIS DATA MAY NOT BE SUITABLE FOR OTHER PURPOSES AND THEREFORE WRITTEN AUTHORITY IS NEEDED FROM **Approved Plans -**VECTA FOR ANY OTHER USE OR REPRODUCTION. Whangarei District MAJOR CONTOURS ARE AT 1m INTERVALS Council RCA -SD2200045 MINOR CONTOURS ARE AT 0.2m INTERVALS JF 19/12/2022 LOCAL AUTHORITY: WHANGAREI DISTRICT COUNCIL COORDINATE SYSTEM: NZGD MT EDEN 2000 LEVELS DATUM: ONE TREE POINT DATUM 1964 ORIGIN OF COORDINATES: DD 7 (AAV6) ORIGIN OF LEVELS: DD 7 (AAV6) RL= 3.868m EASEMENT L SURVEY DATE: DP 159932 16TH JULY 2021 (FIRST GAS PIPELINE) 18TH JULY 2022 (CHANNEL PIPELINE) THE UNDERGROUND SERVICES SHOWN ON THIS PLAN HAVE BEEN LOCATED AND GROUND MARKED BY A FIRST GAS Part Section REPRESENTATIVE ONSITE, WITH THAT MARKED LOCATION THEN SURVEYED BY VECTA. NO EXCAVATION OR TEST PITS WERE 8 Block COMPLETED TO CONFIRM THE POSITIONS OR DEPTHS OF THE SERVICE AND FIRST GAS SHOULD BE CONSULTED ON THE ACCURACY OF THE GROUND MARKED LOCATIONS/DEPTHS OF THE PIPE. UNDERGROUND SERVICES SHOWN ON THIS PLAN HAVE NOT BEEN VERIFIED BY VECTA AND ALL UNDERGROUND EASEMENT E INFORMATION DISPLAYED ON THIS PLAN HAS BEEN PROVIDED DP 390099 TO VECTA BY THIRD PARTIES. AS A RESULT, VECTA ACCEPTS NO LIABILITY FOR THE SERVICES SHOWN OR OMITTED FROM THIS PLAN Lot 8 DP 55607 EASEMENT D EASEMENT F DP 390099 AND. LOCATED FIRST GAS PIPELINE TRISHN NAND EASEMENT L DP 159932 **LEGEND** EASEMENT E EASEMENT F DP 99076 DP 99076 PARCEL BOUNDARY LOCATED CHANNEL PIPELINE ABBUTALL BOUNDARY **EASEMENT BOUNDARY** FIRST GAS PIPELINE **CHANNEL PIPELINE** Lot 1 130 **CHAINAGE LABELS** DP 406479 15-12-2022 DATE CREATED FOR APPROVAL - RESPONSE TO RFI'S 2 AP TN 31-08-2020 HKRS HOLDINGS LTD 06-12-2022 VECTA REF NO FIRST GAS & CHANNEL PIPELINES **DEVELOPMENT OF** FOR APPROVAL - RESPONSE TO RFI'S 1 1:1250 @ A3 AP TN P0318 FOR APPROVAL BREAM BAY BUSINESS HUB - STAGE 1A & 1 SURVEY PLAN 04-11-2022 FOR APPROVAL DETAIL DESIGN ENGINEERING PLANS DWG NUMBER AP TN **DD600**

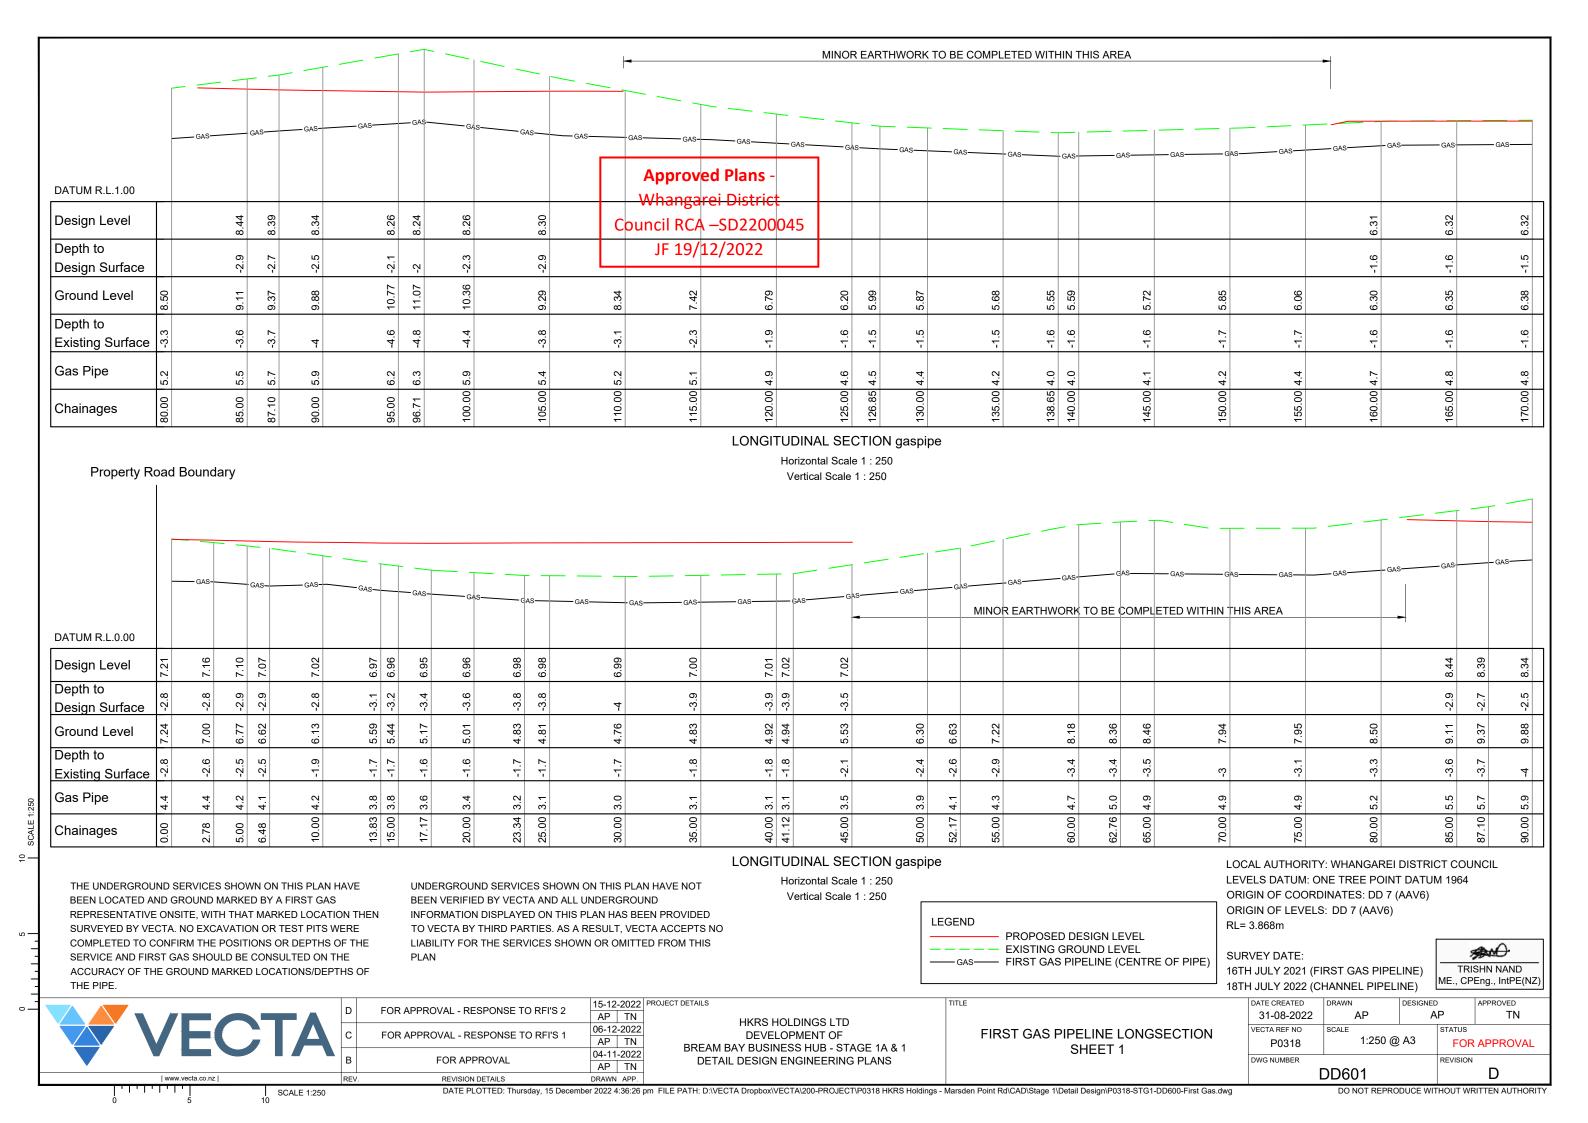

#### LONGITUDINAL SECTION gaspipe

Horizontal Scale 1: 250 Vertical Scale 1 : 250

		— GAS———	GAS——GAS—	GAS——	GAS——— G	AS———GAS	GAS———GAS—	GAS-	GAS	GAS———G	as	GAS	GAS-	GASGAS	GAS——	GAS——— GA	S———GAS——	GAS-	- GAS	GAS
DATUM R.L1.00																				
Design Level	6.31	6.32		6.32	9.30	6.24	6.14	90.9	5.97	5.91	5.87		5.79	5.69	5.53	5.47	5.44	5.42	5.40	5.36
Depth to Design Surface	-1.6	6.1-		<u> </u>		-2.2	-2.4	-2.6	-2.8	ę.	-3.2		-3.3	-3.4	-3.5	-3.6	-3.6	-3.6	-3.6 -3.6	-3.5
Ground Level	6.30	6.35	6.38	8, 8	2 88	5.65	5.37	5.14	4.82	4.57	4 39		4.02	3.67	3.55	3.43	3.37	3.32	3.28	3.34
Depth to Existing Surface	-1.6	-1 6.	6. 4. 6. 6. 6. 6. 6. 6. 6. 6. 6. 6. 6. 6. 6.	0. 9.	9	-1.6	6.	-1.6	<u>7</u> 6.	-1.7	-17		5.	<u>-</u> 4:	<u>-</u> 5:	1.6	-1 6.	-1.5	2. L 3. L	5.
Gas Pipe	4.7	8. 8.	4, 4	o 4 o 6	. 4 ω	0.4 0.0	3.7	3.5	3.2	2.9	2.7	2.7	4.2	2.2	2.0	<u>~</u>	<del>6</del> 8.	1.8	<u>4</u>	6.
Chainages	160.00	165.00	6 2	175.00	180.00	183.89	190.00	195.00	200.00	205.00	208 47	210.00	215.00	220.00	225.00	230.00	235.00	240.00	243.78	250.00

#### LONGITUDINAL SECTION gaspipe

Horizontal Scale 1:250

Vertical Scale 1 : 250

THE UNDERGROUND SERVICES SHOWN ON THIS PLAN HAVE BEEN LOCATED AND GROUND MARKED BY A FIRST GAS REPRESENTATIVE ONSITE. WITH THAT MARKED LOCATION THEN SURVEYED BY VECTA. NO EXCAVATION OR TEST PITS WERE COMPLETED TO CONFIRM THE POSITIONS OR DEPTHS OF THE SERVICE AND FIRST GAS SHOULD BE CONSULTED ON THE ACCURACY OF THE GROUND MARKED LOCATIONS/DEPTHS OF THE PIPE.

SCALE 1:250

UNDERGROUND SERVICES SHOWN ON THIS PLAN HAVE NO BEEN VERIFIED BY VECTA AND ALL UNDERGROUND INFORMATION DISPLAYED ON THIS PLAN HAS BEEN PROVIDED TO VECTA BY THIRD PARTIES. AS A RESULT, VECTA ACCEPTS NO LIABILITY FOR THE SERVICES SHOWN OR OMITTED FROM THIS COUNCIL RCA —SD2200045 PLAN

**Approved Plans -**Whangarei District JF 19/12/2022

**LEGEND** PROPOSED DESIGN LEVEL EXISTING GROUND LEVEL GAS—— FIRST GAS PIPELINE (CENTRE OF PIPE) LOCAL AUTHORITY: WHANGAREI DISTRICT COUNCIL LEVELS DATUM: ONE TREE POINT DATUM 1964 ORIGIN OF COORDINATES: DD 7 (AAV6) ORIGIN OF LEVELS: DD 7 (AAV6)

RL= 3.868m

SURVEY DATE: 16TH JULY 2021 (FIRST GAS PIPELINE) 18TH JULY 2022 (CHANNEL PIPELINE)

MANO. TRISHN NAND ME., CPEng., IntPE(NZ)

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V L O I	

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1	D	FOR APPROVAL - RESPONSE TO RFI'S 2	15-12	-2022	PROJECT DETAILS
	ט	FOR APPROVAL - RESPONSE TO RFTS 2	AP	TN	
	С	FOR APPROVAL - RESPONSE TO REI'S 1	06-12	-2022	
	C	FOR AFFROVAL - RESPONSE TO KFIS T	AP	TN	חחראי
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HKRS HOLDINGS LTD DEVELOPMENT OF BREAM BAY BUSINESS HUB - STAGE 1A & 1 DETAIL DESIGN ENGINEERING PLANS

FIRST GAS PIPELINE LONGSECTION SHEET 2

		,				
DATE CREATED	DRAWN	DESIGNED	)	APPROVED		
31-08-2022	AP	AP		AP TN		TN
VECTA REF NO	SCALE		STATUS			
P0318	1:250 @ A3		FOR APPROVAL			
DWG NUMBER			REVISION			
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DO NOT REPRODUCE WITHOUT WRITTEN AUTHORITY						

DATE PLOTTED: Thursday, 15 December 2022 4:36:31 pm FILE PATH: D:\VECTA Dropbox\VECTA\200-PROJECT\P0318 HKRS Holdings - Marsden Point Rd\CAD\Stage 1\Detail Design\P0318-STG1-DD600-First Gas.dwg

## LONGITUDINAL SECTION gaspipe

Horizontal Scale 1 : 250 Vertical Scale 1 : 250

THE UNDERGROUND SERVICES SHOWN ON THIS PLAN HAVE BEEN LOCATED AND GROUND MARKED BY A FIRST GAS REPRESENTATIVE ONSITE, WITH THAT MARKED LOCATION THEN SURVEYED BY VECTA. NO EXCAVATION OR TEST PITS WERE COMPLETED TO CONFIRM THE POSITIONS OR DEPTHS OF THE SERVICE AND FIRST GAS SHOULD BE CONSULTED ON THE ACCURACY OF THE GROUND MARKED LOCATIONS/DEPTHS OF THE PIPE.

UNDERGROUND SERVICES SHOWN ON THIS PLAN HAVE NOT BEEN VERIFIED BY VECTA AND ALL UNDERGROUND INFORMATION DISPLAYED ON THIS PLAN HAS BEEN PROVIDED TO VECTA BY THIRD PARTIES. AS A RESULT, VECTA ACCEPTS NO LIABILITY FOR THE SERVICES SHOWN OR OMITTED FROM THIS PLAN

LEGEND

PROPOSED DESIGN LEVEL

PROPOSED DESIGN LEVEL


SAS FIRST GAS PIPELINE (CENTRE OF PIPE)

**Approved Plans -**

Whangarei District Council RCA –SD2200045 JF 19/12/2022

LOCAL AUTHORITY: WHANGAREI DISTRICT COUNCIL LEVELS DATUM: ONE TREE POINT DATUM 1964 ORIGIN OF COORDINATES: DD 7 (AAV6) ORIGIN OF LEVELS: DD 7 (AAV6) RL= 3.868m

SURVEY DATE: 16TH JULY 2021 (FIRST GAS PIPELINE) 18TH JULY 2022 (CHANNEL PIPELINE)

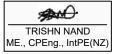

VECTA:


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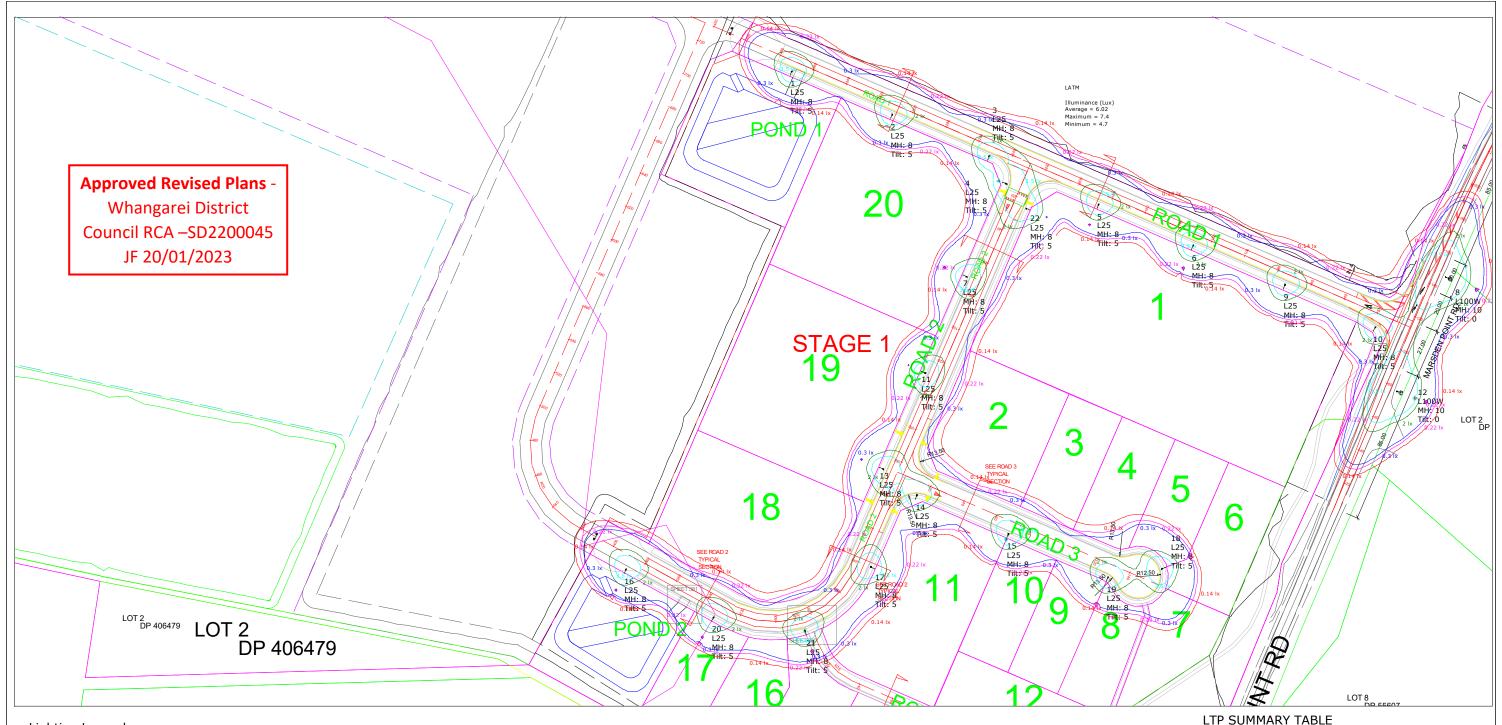
HKRS HOLDINGS LTD DEVELOPMENT OF BREAM BAY BUSINESS HUB - STAGE 1A & 1 DETAIL DESIGN ENGINEERING PLANS

FIRST GAS PIPELINE LONGSECTION SHEET 3

00E1 2022 (011/11/14EE1 11 EE1/4E)						
DATE CREATED	DRAWN	DESIGNED	)	APPROVED		
31-08-2022	AP	AP A		TN		
VECTA REF NO	SCALE		STATUS			
P0318	1:250 @	A3	FOR APPROVAL			
DWG NUMBER			REVISION			
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DO NOT REPRODUCE WITHOUT WRITTEN AUTHORITY						

DATE PLOTTED: Thursday, 15 December 2022 4:36:36 pm FILE PATH: D:\VECTA Dropbox\VECTA\200-PROJECT\P0318 HKRS Holdings - Marsden Point Rd\CAD\Stage 1\Detail Design\P0318-STG1-DD600-First Gas.dwg



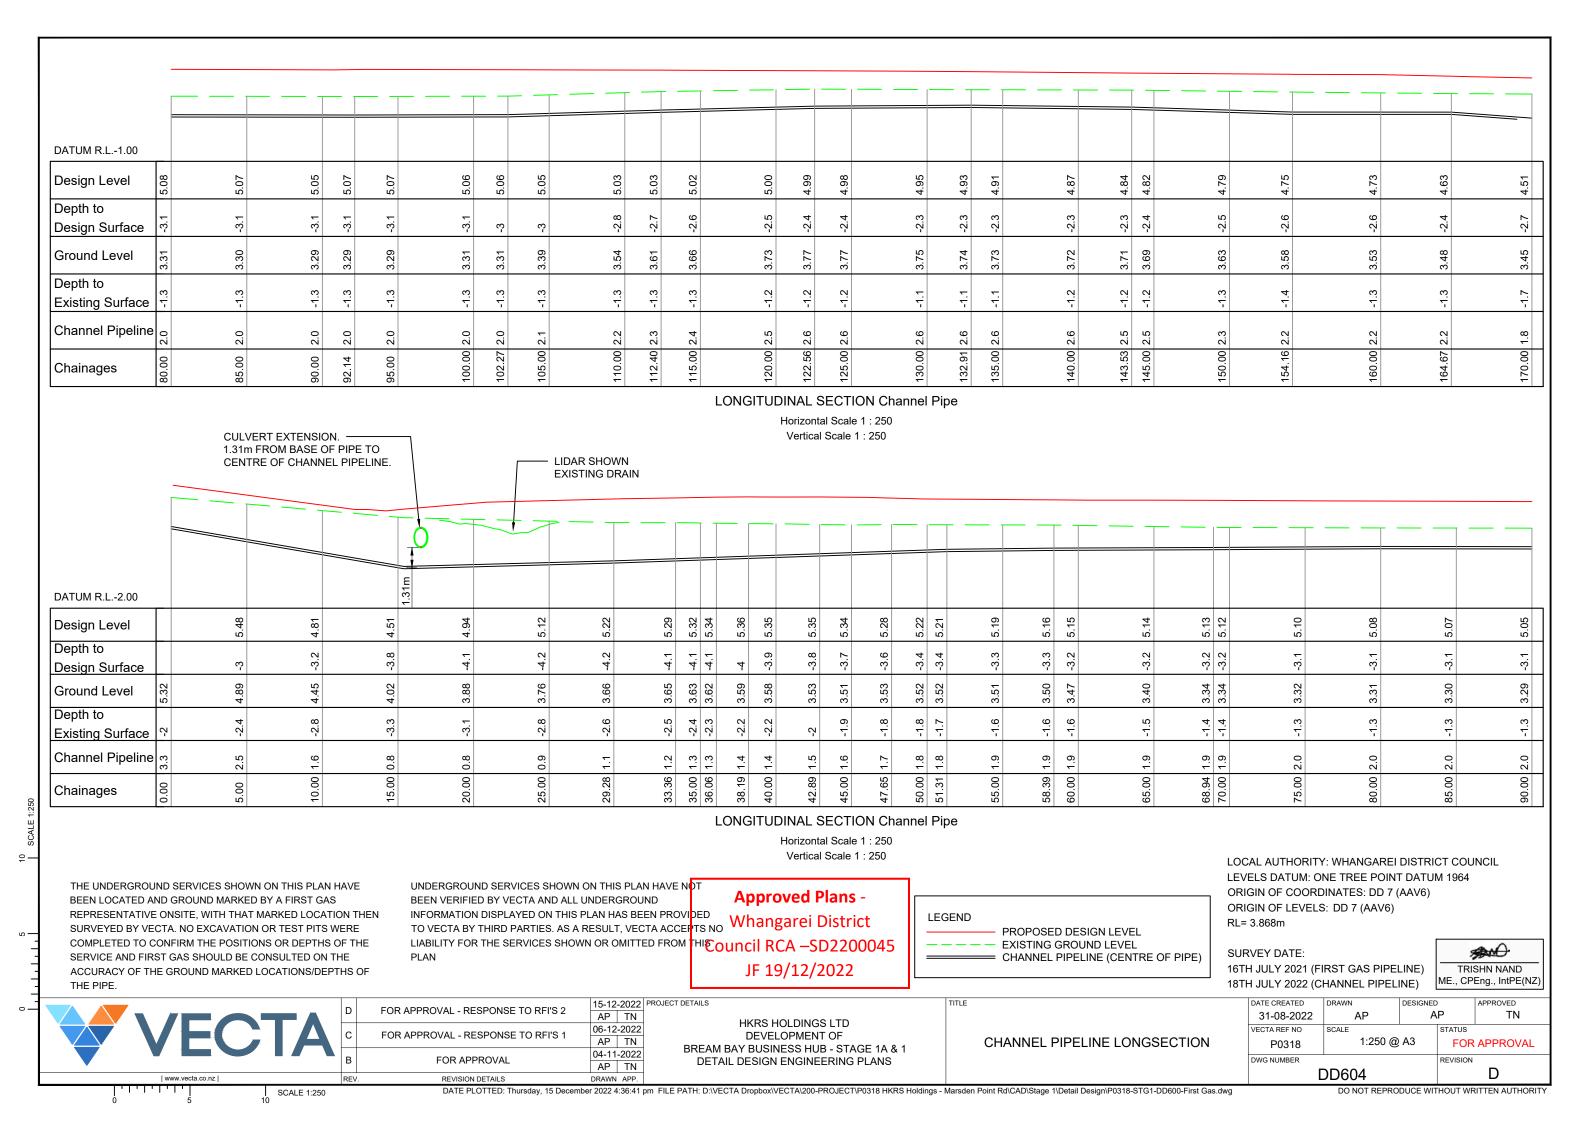

## Lighting Legend:-

- 1. Luminiare type identified individually for each location and height.
- 2. Magenta isolux line shows a AS/NZS 1158.3.1 PR4 0.22 Lux compliance.
- 3. Luminaires are indicated by BLACK rectangle.
- 4. Column location is around 2.6m behind the optical centre
- 5. Maintenance Factor is 0.8

- 6. 6A HRC Fuse is required for AT TDM Chapter 12.
- 7. Luminaires will be CMS ready, Specifiy 7 pin NEMA socket and Zodion SS6 photocell. Philips Xitanium driver with DALI.
- 8. Columns CSP Pacific 8m with 2.0m outreach.
- 9. The luminaires used must comply with AT Design Manual Glare Requirement.
- 10. Power density is 0.021 W/m2

#### ETT SOTTIAKT TABLE

Eh(ave)	Eph(min)	UE2	IG80	IPEAK
>1.30	>0.22	<8	393	1191

## **BETACOM**

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R4	12/12/2022	REVISED AS PER PEER REVIEW.	A.RUITER
R5	21/12/2022	LATM ADDED.	A.RUITER

<u> </u>	PROJECT BREAM BAY BUSINESS PARK CAT PR4	Aaron Parker MACROVENTURES	REVISION R5 SHEET A3
	CONTACT  Jeff.Richardson@betacom.co.nz	DOCUMENT NO. Bream Bay Business hub.AGI	PAGE NO. Page 1 of 5

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I-table Filename: C:\Users\andre\Desktop\Use ful folders\I TABLES FO R PERFECT LITE\TECEO 1 5068 16 XP-G3 500mA WW 730 25.8W 7x7 III-Medium 407512 Flat glass 230V TF.cie

Job Name: BREAM BAY BUSINESS HUB

Luminaire Description: 5068 WW 25.8W 3142 lms

Lamp Wattage & Type: LED 25.8 Initial Lamp Flux: 3142 lms Maintenance Factor: 0.8 Upcast Angle: 5 degrees Arrangement: Single Side Offset Distance: 2.6 m

Upward Waste Light Ratio: .0 %

Light Source: LED - Light Emitting Diode

Lighting Category: PR4

Illuminance Criteria: Average Illuminance (Eav) >= 1.30 lx (Maintained values) Minimum Illuminance (Eph) >= 0.22 lx

Illuminance Uniformity (Up) <= 8

Minimum Illuminance (Epv) >= NOT assessed

Calculation Grid: 20 x 11 points - Figure 3.7 of AS/NZS 1158.2

Mounting Height Maximum Spacing for different Road Reserve Widths

19.0 20.0 +-----+ 8.0 | 59.3 56.7 |

Value/s in above table are all in metres.

The table contains maximum spacings which, for the specified luminaire and lamp combination, provide compliance with the User Defined light technical parameters (LTPs) nominated above.

\_\_\_\_\_

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#### LUMINAIRE INTENSITY REPORT

I-table Filename: C:\Users\andre\Desktop\Use ful folders\I TABLES FOR PERFECT LITE\TECEO 1 5068 16 XP-G3 500mA WW 730 25.8W 7x7 III-Medium 407512 Flat glass 230V TF.cie

Luminaire Description: 5068 WW 25.8W 3142 lms

Lamp Wattage & Type: LED 25.8W Initial Lamp Flux: 3142 lms Upcast angle: 5 degrees Upward Waste Light Ratio: .0 %

Light Source: LED - Light Emitting Diode

Maximum intensity at G=80: 125 Cd/1000 lamp lumens (393 Cds)

(at C = 15 degrees)

Maximum intensity at G=90: 0 Cd/1000 lamp lumens (0 Cds)

(at C = 0 degrees)

Peak intensity: 379 Cd/1000 lamp lumens (1191 Cds) (at: C = 15 degrees & G = 67.5 degrees) Intensity at G=90 degrees: 0 Cd/1000 lamp lumens (0 Cds) (in Peak Intensity vertical plane)

-----

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Luminair	inaire Schedule						
Symbol	Qty	Label	Tag	LLF	Luminaire	Total	
					Watts	Watts	
—	20	TECEO 1 5068 16 XP-G3 500mA W	L25	0.800	25.8	516	
——а	2	SL99N23303L100	L100W	0.800	101.82	203.64	


Calculation Summary					
Label	CalcType	Units	Avg	Max	Min
LATM	Illuminance	Lux	6.02	7.4	4.7

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PROJECT  BREAM BAY BUSINESS PARK  CAT PR4	CLIENT Aaron Parker MACROVENTURES	REVISION R5
CONTACT Jeff.Richardson@betacom.co.nz	DOCUMENT NO. Bream Bay Business hub.AGI	PAGE NO. Page 2 of 5



## SIMULATED RENDER

BETACOM 80 MACES RD, BROMLEY
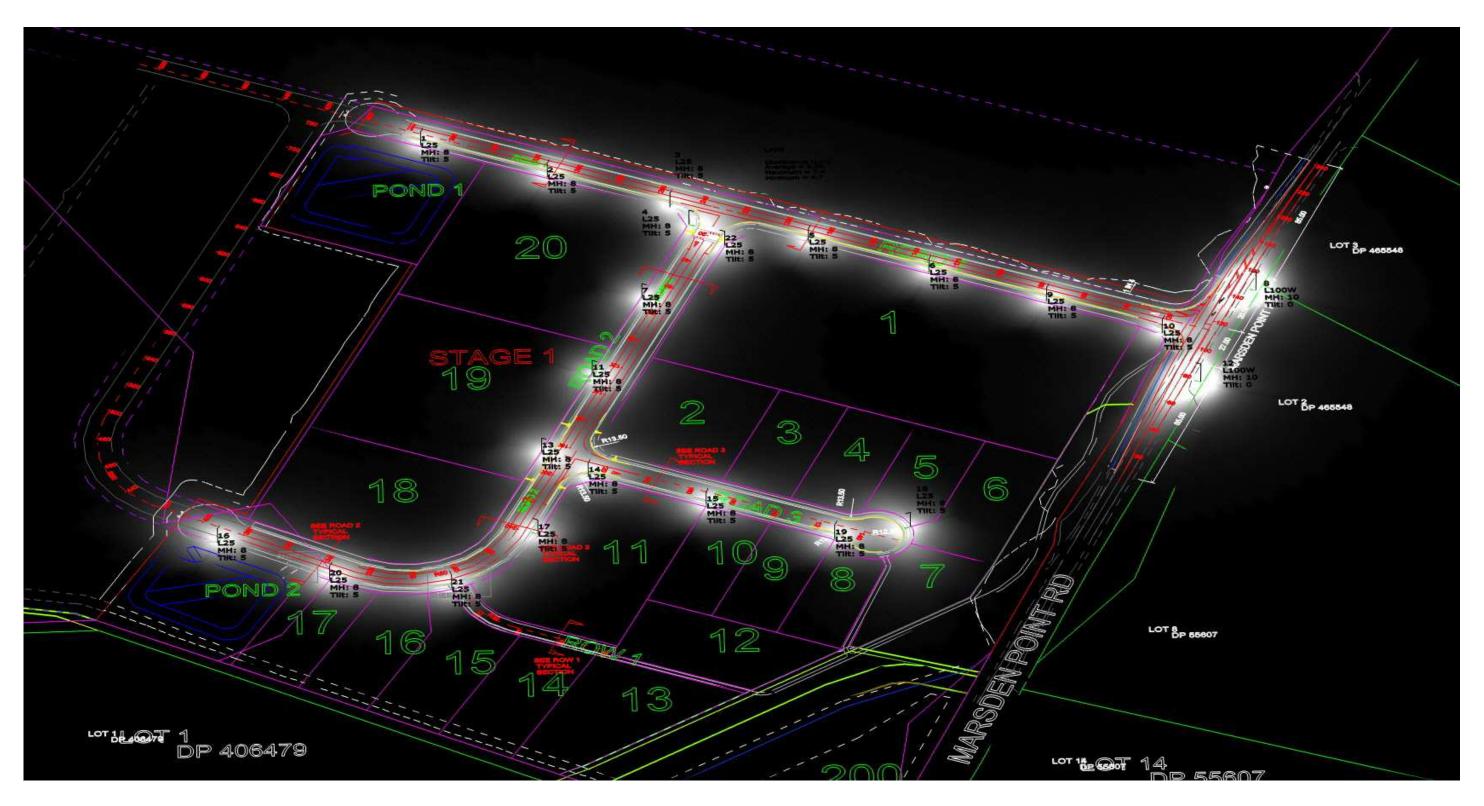
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R3	29/11/2022	REVISED AS PER PEER REVIEW.	A.RUITER	CONTACT
R4	12/12/2022	REVISED AS PER PEER REVIEW.	A.RUITER	Jeff.Ric
R5	21/12/2022	LATM ADDED.	A.RUITER	0011.100

**CLIENT PROJECT** BREAM BAY BUSINESS PARK Aaron Parker CAT PR4

MACROVENTURES


Whangarei District Council RCA -SD2200045 JF 20/01/2023

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revision R5 SHEET А3

DOCUMENT NO. Jeff.Richardson@betacom.co.nz Bream Bay Business hub.AGI

PAGE NO. Page 3 of 5

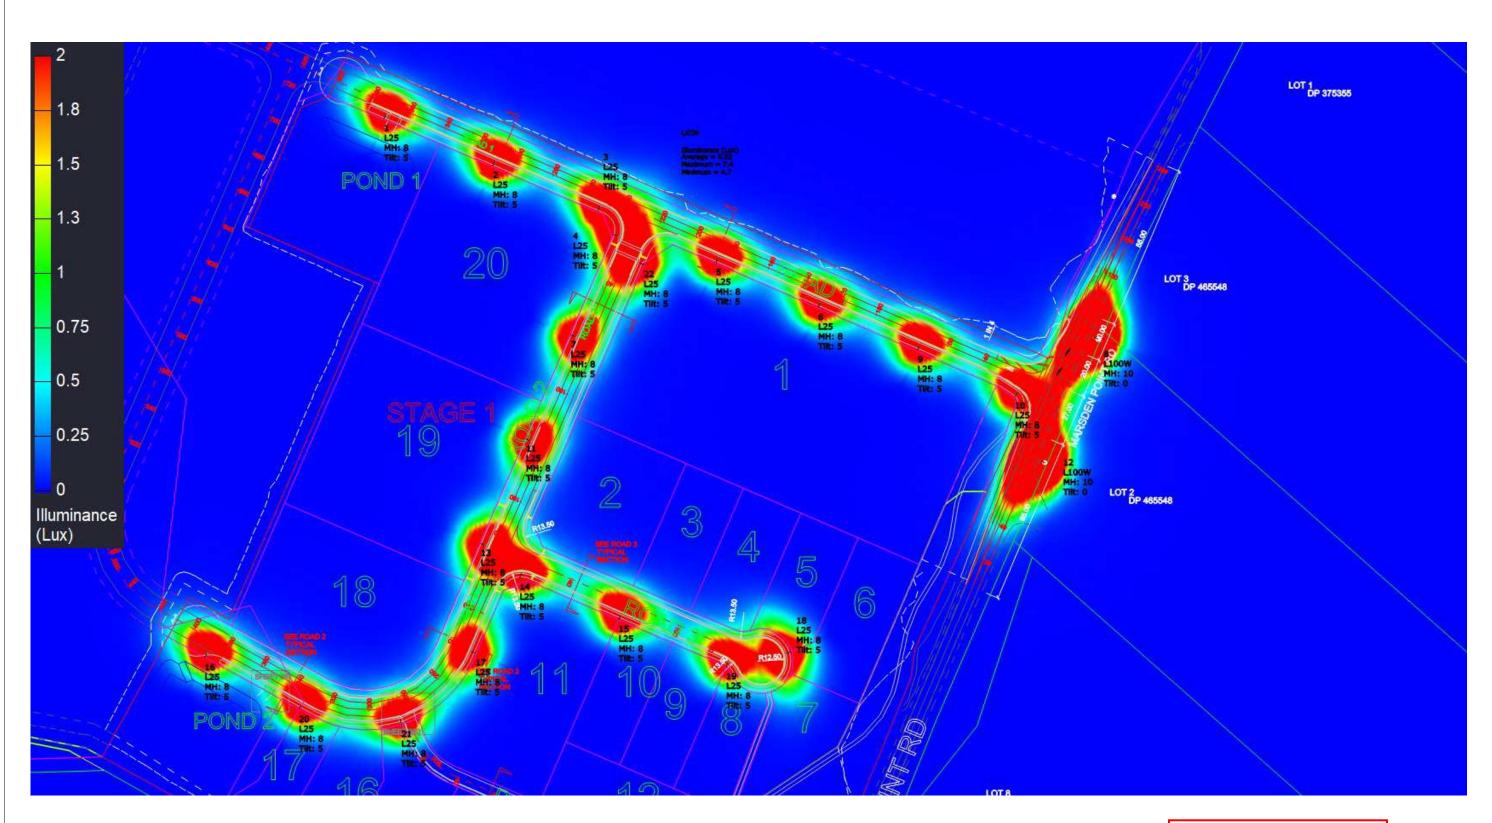

## SIMULATED ISOLUX

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80 MACES RD, BROMLEY
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TEL HEAR 2 2014 1042

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**PROJECT** BREAM BAY BUSINESS PARK CAT PR4

Jeff.Richardson@betacom.co.nz

Aaron Parker

**CLIENT** 

**MACROVENTURES** DOCUMENT NO.
Bream Bay Business hub.AGI

Council RCA -SD2200045 revision R5 JF 20/01/2023

> SHEET A3

PAGE NO. Page 4 of 5

**Approved Revised Plans -**Whangarei District

Luminai	re Location Summary					
		Insertion Poir	nt			
LumNo	Label	X	Υ	Z	Orient	Tilt
1	TECEO 1 5068 16 XP-G3 500mA W	372471.348	913007.965	8	66.642	5
2	TECEO 1 5068 16 XP-G3 500mA W	372526.989	912984.004	8	66.642	5
3	TECEO 1 5068 16 XP-G3 500mA W	372580.65	912961.119	8	66.642	5
4	TECEO 1 5068 16 XP-G3 500mA W	372588.674	912948.718	8	338.692	5
5	TECEO 1 5068 16 XP-G3 500mA W	372640.985	912934.458	8	66.642	5
6	TECEO 1 5068 16 XP-G3 500mA W	372693.279	912911.648	8	66.642	5
7	TECEO 1 5068 16 XP-G3 500mA W	372566.812	912897.418	8	337.816	5
8	SL99N23303L100	372836.329	912895.346	10	158.296	0
9	TECEO 1 5068 16 XP-G3 500mA W	372744.123	912889.936	8	66.642	5
10	TECEO 1 5068 16 XP-G3 500mA W	372793.912	912866.364	8	64.115	5
11	TECEO 1 5068 16 XP-G3 500mA W	372543.907	912844.343	8	336.642	5
12	SL99N23303L100	372809.28	912832.241	10	160.105	0
13	TECEO 1 5068 16 XP-G3 500mA W	372520.782	912791.051	8	336.642	5
14	TECEO 1 5068 16 XP-G3 500mA W	372540.652	912773.619	8	66.762	5
15	TECEO 1 5068 16 XP-G3 500mA W	372591.266	912752.167	8	67.016	5
16	TECEO 1 5068 16 XP-G3 500mA W	372379.647	912732.664	8	63.686	5
17	TECEO 1 5068 16 XP-G3 500mA W	372518.086	912735.002	8	154.522	5
18	TECEO 1 5068 16 XP-G3 500mA W	372679.187	912735.74	8	202.036	5
19	TECEO 1 5068 16 XP-G3 500mA W	372646.263	912728.127	8	67.818	5
20	TECEO 1 5068 16 XP-G3 500mA W	372427.812	912706.182	8	61.197	5
21	TECEO 1 5068 16 XP-G3 500mA W	372480.244	912698.577	8	107.059	5
22	TECEO 1 5068 16 XP-G3 500mA W	372604.097	912933.365	8	156.642	5

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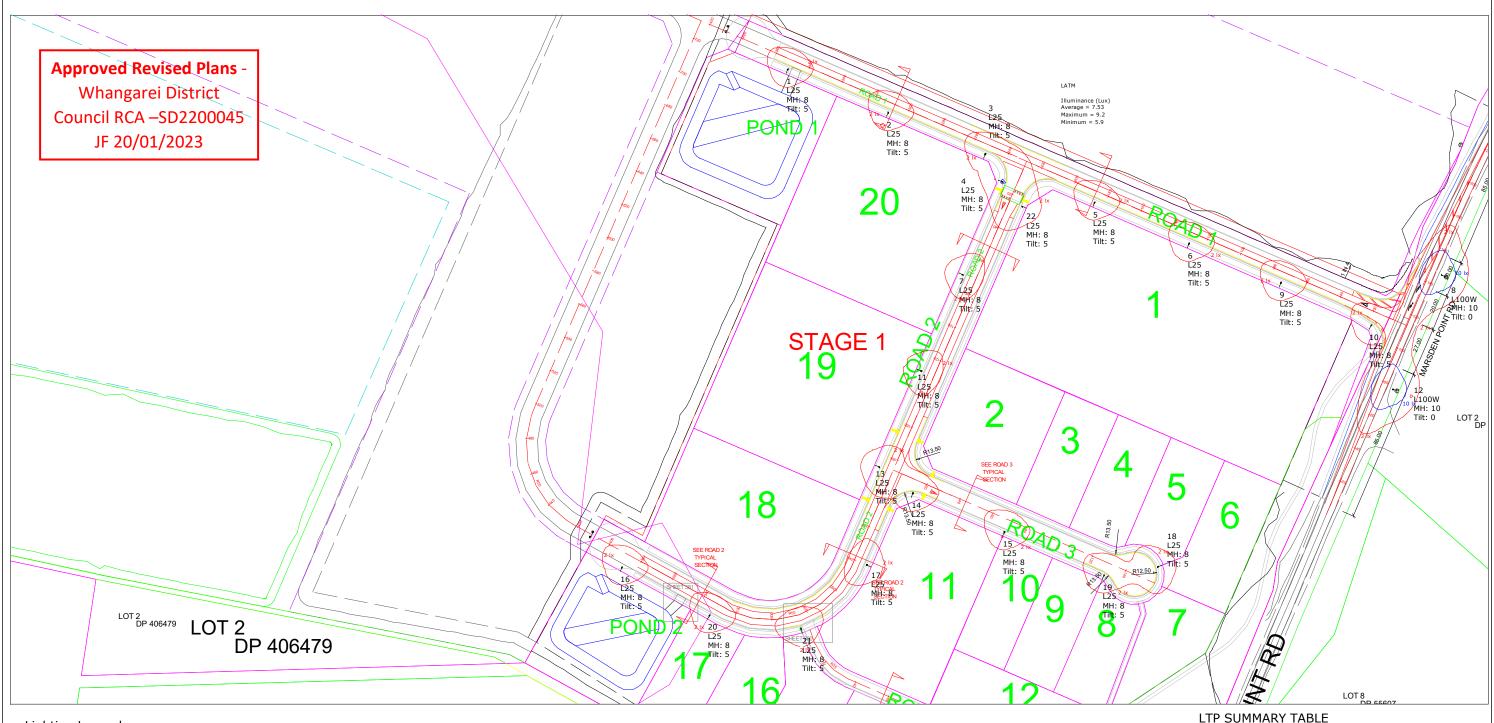
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2	<u>PROJECT</u>	CLIENT
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	CONTACT  Jeff.Richardson@betacom.co.nz	DOCUMENT NO. Bream Bay Business hub.AGI

revision R5 SHEET A3 PAGE NO.

Page 5 of 5



## Lighting Legend:-

- 1. Luminiare type identified individually for each location and height.
- 2. RED isolux line shows a 2 Lux level spill compliance.
- 3. Luminaires are indicated by BLACK rectangle.
- 4. Column location is around 2.6m behind the optical centre
- 5. Maintenance Factor is 1

- 6. 6A HRC Fuse is required for AT TDM Chapter 12.
- 7. Luminaires will be CMS ready, Specifiy 7 pin NEMA socket and Zodion SS6 photocell. Philips Xitanium driver with DALI.
- 8. Columns CSP Pacific 8m with 2.0m outreach.
- 9. The luminaires used must comply with AT Design Manual Glare Requirement.
- 10. Power density is 0.021 W/m2

Eh(ave)	Eph(min)	UE2	IG80	IPEAK
>1.30	>0.22	<8	393	1191

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ED	PROJECT	CLIENT	REVISION
	BREAM BAY BUSINESS PARK	Aaron Parker	R5
	CAT PR4	MACROVENTURES	SHEET A3
	CONTACT  Jeff.Richardson@betacom.co.nz	DOCUMENT NO. Spill MF1.AGI	PAGE NO. Page 1 of 1